

Pre-Lodgement Application Form

Applicant contact details

Title	Mr
First given name	Matthew
Other given name/s	
Family name	McQualter
Contact number	
Email	
Address	
Application on behalf of a company, business or body corporate	No

Owner/s of the development site

Owner/s of the development site	I am the only owner of the development site
	l , , , , , , , , , , , , , , , , , , ,

Site access details

Are there any security or site conditions which may impact the person undertaking the inspection? For example, locked gates, animals etc.	No
---	----

Developer details

ABN	
ACN	
Name	
Trading name	
Address	
Email Address	

Development details

Application type	Modification Application
On what date was the development application to be notified determined	21/02/2024
Type of modification requested	S4.55(1A) - Modification involving minimal environmental impact, where the development will remain substantially the same as the development that was originally approved
Development Application number of the consent to be modified	
Description of the proposed modification	To confirm building size and total footprint. To confirm size of the bays in the Industrial shed
Was the DA applied for via the NSW Planning Portal?	Yes
Please provide portal application number (PAN)	PAN-311719
Site address #	1
Street address	76 MCCARTHY STREET MULWALA 2647
Local government area	FEDERATION
Lot / Section Number / Plan	46/-/DP1257361
Primary address?	Yes
	Land Application LEP NA

1

	Land Zoning NA	
	Height of Building NA	
Discription and the last of the state of the	Floor Space Ratio (n:1) NA	
Planning controls affecting property	Minimum Lot Size NA	
	Heritage NA	
	Land Reservation Acquisition NA	
	Foreshore Building Line NA	

Proposed development

Selected common application types	Erection of a new structure
Selected development types	General industry
Description of development	Construction of an new shed on Vacant land
Provide the proposed hours of operation	
Proposed to operate 24 hours on Monday	
Monday	-
Proposed to operate 24 hours on Tuesday	
Tuesday	-
Proposed to operate 24 hours on Wednesday	
Wednesday	-
Proposed to operate 24 hours on Thursday	
Thursday	-
Proposed to operate 24 hours on Friday	
Friday	-
Proposed to operate 24 hours on Saturday	
Saturday	-
Proposed to operate 24 hours on Sunday	
Sunday	-
Dwelling count details	
Number of dwellings / units proposed	
Number of storeys proposed	
Number of pre-existing dwellings on site	
Number of dwellings to be demolished	
Number of proposed occupants	
Existing gross floor area (m2)	
Proposed gross floor area (m2)	576
Total site area (m2)	
Total net lettable area (m2)	
Cost of development	
Estimated cost of work / development (including GST)	\$330,300.00
Capital Investment Value (CIV)	\$330,300.00
Do you have one or more BASIX certificates?	
Climate Zone	
What climate zone/s is the development in?	Climate zone 8 - alpine
Has the climate zone impacted the	<u>'</u>

design of the development?	No
Subdivision	
Number of existing lots	
Proposed operating details	
Number of additional jobs that are proposed to be generated through the operation of the development	
Number of staff/employees on the site	2

Number of parking spaces

Number of loading bays	
Is a new road proposed?	No
Concept development	
Is the development to be staged?	No, this application is not for concept or staged development.
Crown development	
Is this a proposed Crown development?	No

Related planning information

Is the application for integrated development?	No
Is your proposal categorised as designated development?	No
Is your proposal likely to significantly impact on threatened species, populations, ecological communities or their habitats, or is it located on land identified as critical habitat?	No
Is this application for biodiversity compliant development?	
Does the application propose a variation to a development standard in an environmental planning instrument (eg LEP or SEPP)?	No
Is the application accompanied by a Planning Agreement ?	No
Section 68 of the Local Government Act	
Is approval under s68 of the Local Government Act 1993 required?	Yes
Have you already applied for approval under s68 of the Local Government Act?	No
Would you like to apply for approval under s68 of the Local Government Act?	No
10.7 Certificate	
Have you already obtained a 10.7 certificate?	
Tree works	
Is tree removal and/or pruning work proposed?	No
Local heritage	
Does the development site include an item of environmental heritage or sit within a heritage conservation area.	No
Are works proposed to any heritage listed buildings?	No

Is heritage tree removal proposed?	No
Affiliations and Pecuniary interests	
Is the applicant or owner a staff member or councillor of the council assessing the application?	No
Does the applicant or owner have a relationship with any staff or councillor of the council assessing the application?	No
Political Donations	
Are you aware of any person who has financial interest in the application who has made a political donation or gift in the last two years?	No
Please provide details of each donation/gift which has been made within the last 2 years	

Sustainable Buildings

Is the development exempt from the <u>State</u> <u>Environmental Policy (Sustainable</u> <u>Buildings) 2022</u> Chapter 3, relating to non-residential buildings?	Yes
Provide reason for exemption. Is the development any of the following:	A modification or a review to a development application, or a review of determination, where the original application was submitted on the NSW Planning Portal before 1 October 2023.

Payer details

Provide the details of the person / entity that will make the fee payment for the assessment.

The Environmental Planning and Assessment Regulation 2021 and Council's adopted fees and charges establish how to calculate the fee payable for your development application. For development that involves building or other works, the fee for your application is based on the estimated cost of the development.

If your application is for integrated development or requires concurrence from a state agency, additional fees will be required. Other charges may be payable based on the Council's adopted fees and charges. If your development needs to be advertised, the Council may charge additional advertising fees. Once this application form is completed, it and the supporting documents will be submitted to the Council for lodgement, at which time the fees will be calculated. The Council will contact you to obtain payment. Note: When submitting documents via the NSW Planning Portal, credit card information should not be displayed on documents attached to your development application. The relevant consent authority will contact you to seek payment.

The application may be cancelled if the fees are not paid:

First name	Matthew
Other given name(s)	
Family name	McQualter
Contact number	
Email address	
Billing address	

Application documents


The following documents support the application.


Document type	Document file name			
Other	DA Modification cover letter			
Site Plans	76 McCarthy St Mulwala DA-CC drawings REV2 23-11-23			


Applicant declarations

I declare that all the information in my application and accompanying documents is , to the best of my knowledge, true and correct.	Yes

I understand that the development application and the accompanying information will be provided to the appropriate consent authority for the purposes of the assessment and determination of this development application.	Yes
I understand that if incomplete, the consent authority may request more information, which will result in delays to the application.	Yes
I understand that the consent authority may use the information and materials provided for notification and advertising purposes, and materials provided may be made available to the public for inspection at its Offices and on its website and/or the NSW Planning Portal	Yes
I acknowledge that copies of this application and supporting documentation may be provided to interested persons in accordance with the Government Information (Public Access) 2009 (NSW) (GIPA Act) under which it may be required to release information which you provide to it.	Yes
I agree to appropriately delegated assessment officers attending the site for the purpose of inspection.	Yes
I agree to pay any required NSW Planning Portal Service Fee/s specified under Schedule 4 of the Environmental Planning and Assessment Regulation 2021 to the Department of Planning, Housing and Infrastructure.	Yes
I have read and agree to the collection and use of my personal information as outlined in the Privacy Notice	Yes
I confirm that the change(s) entered is/are made with appropriate authority from the applicant(s).	

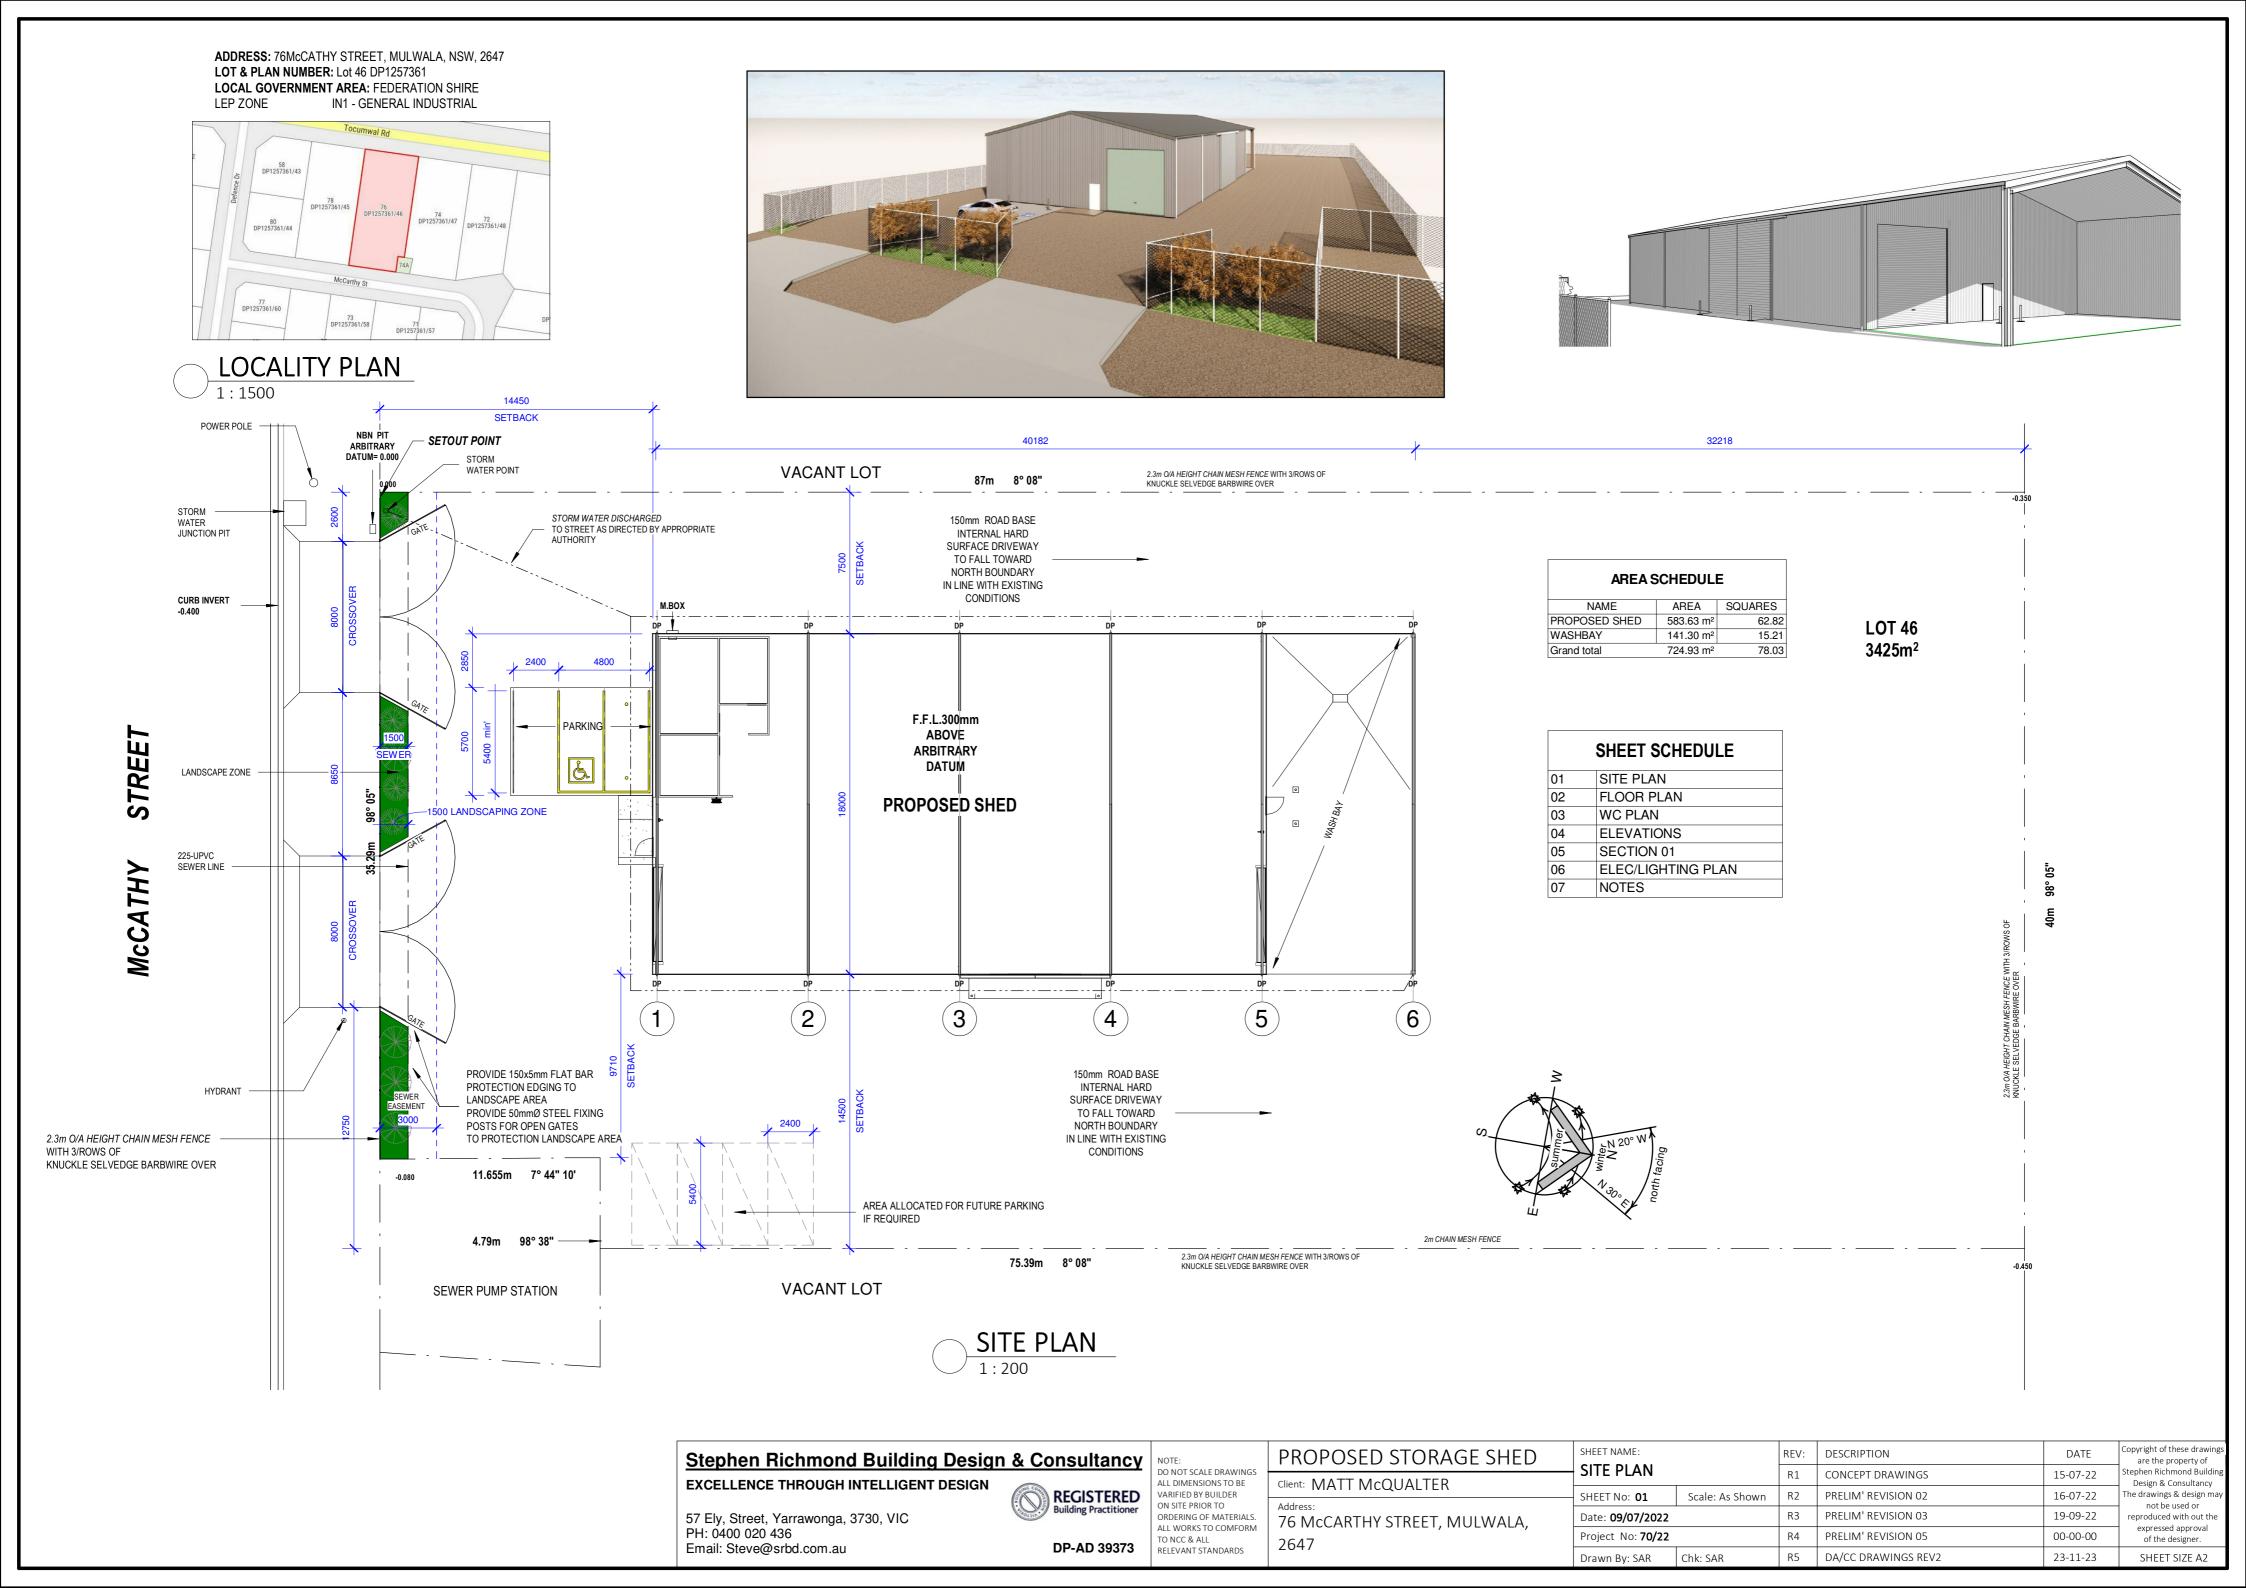

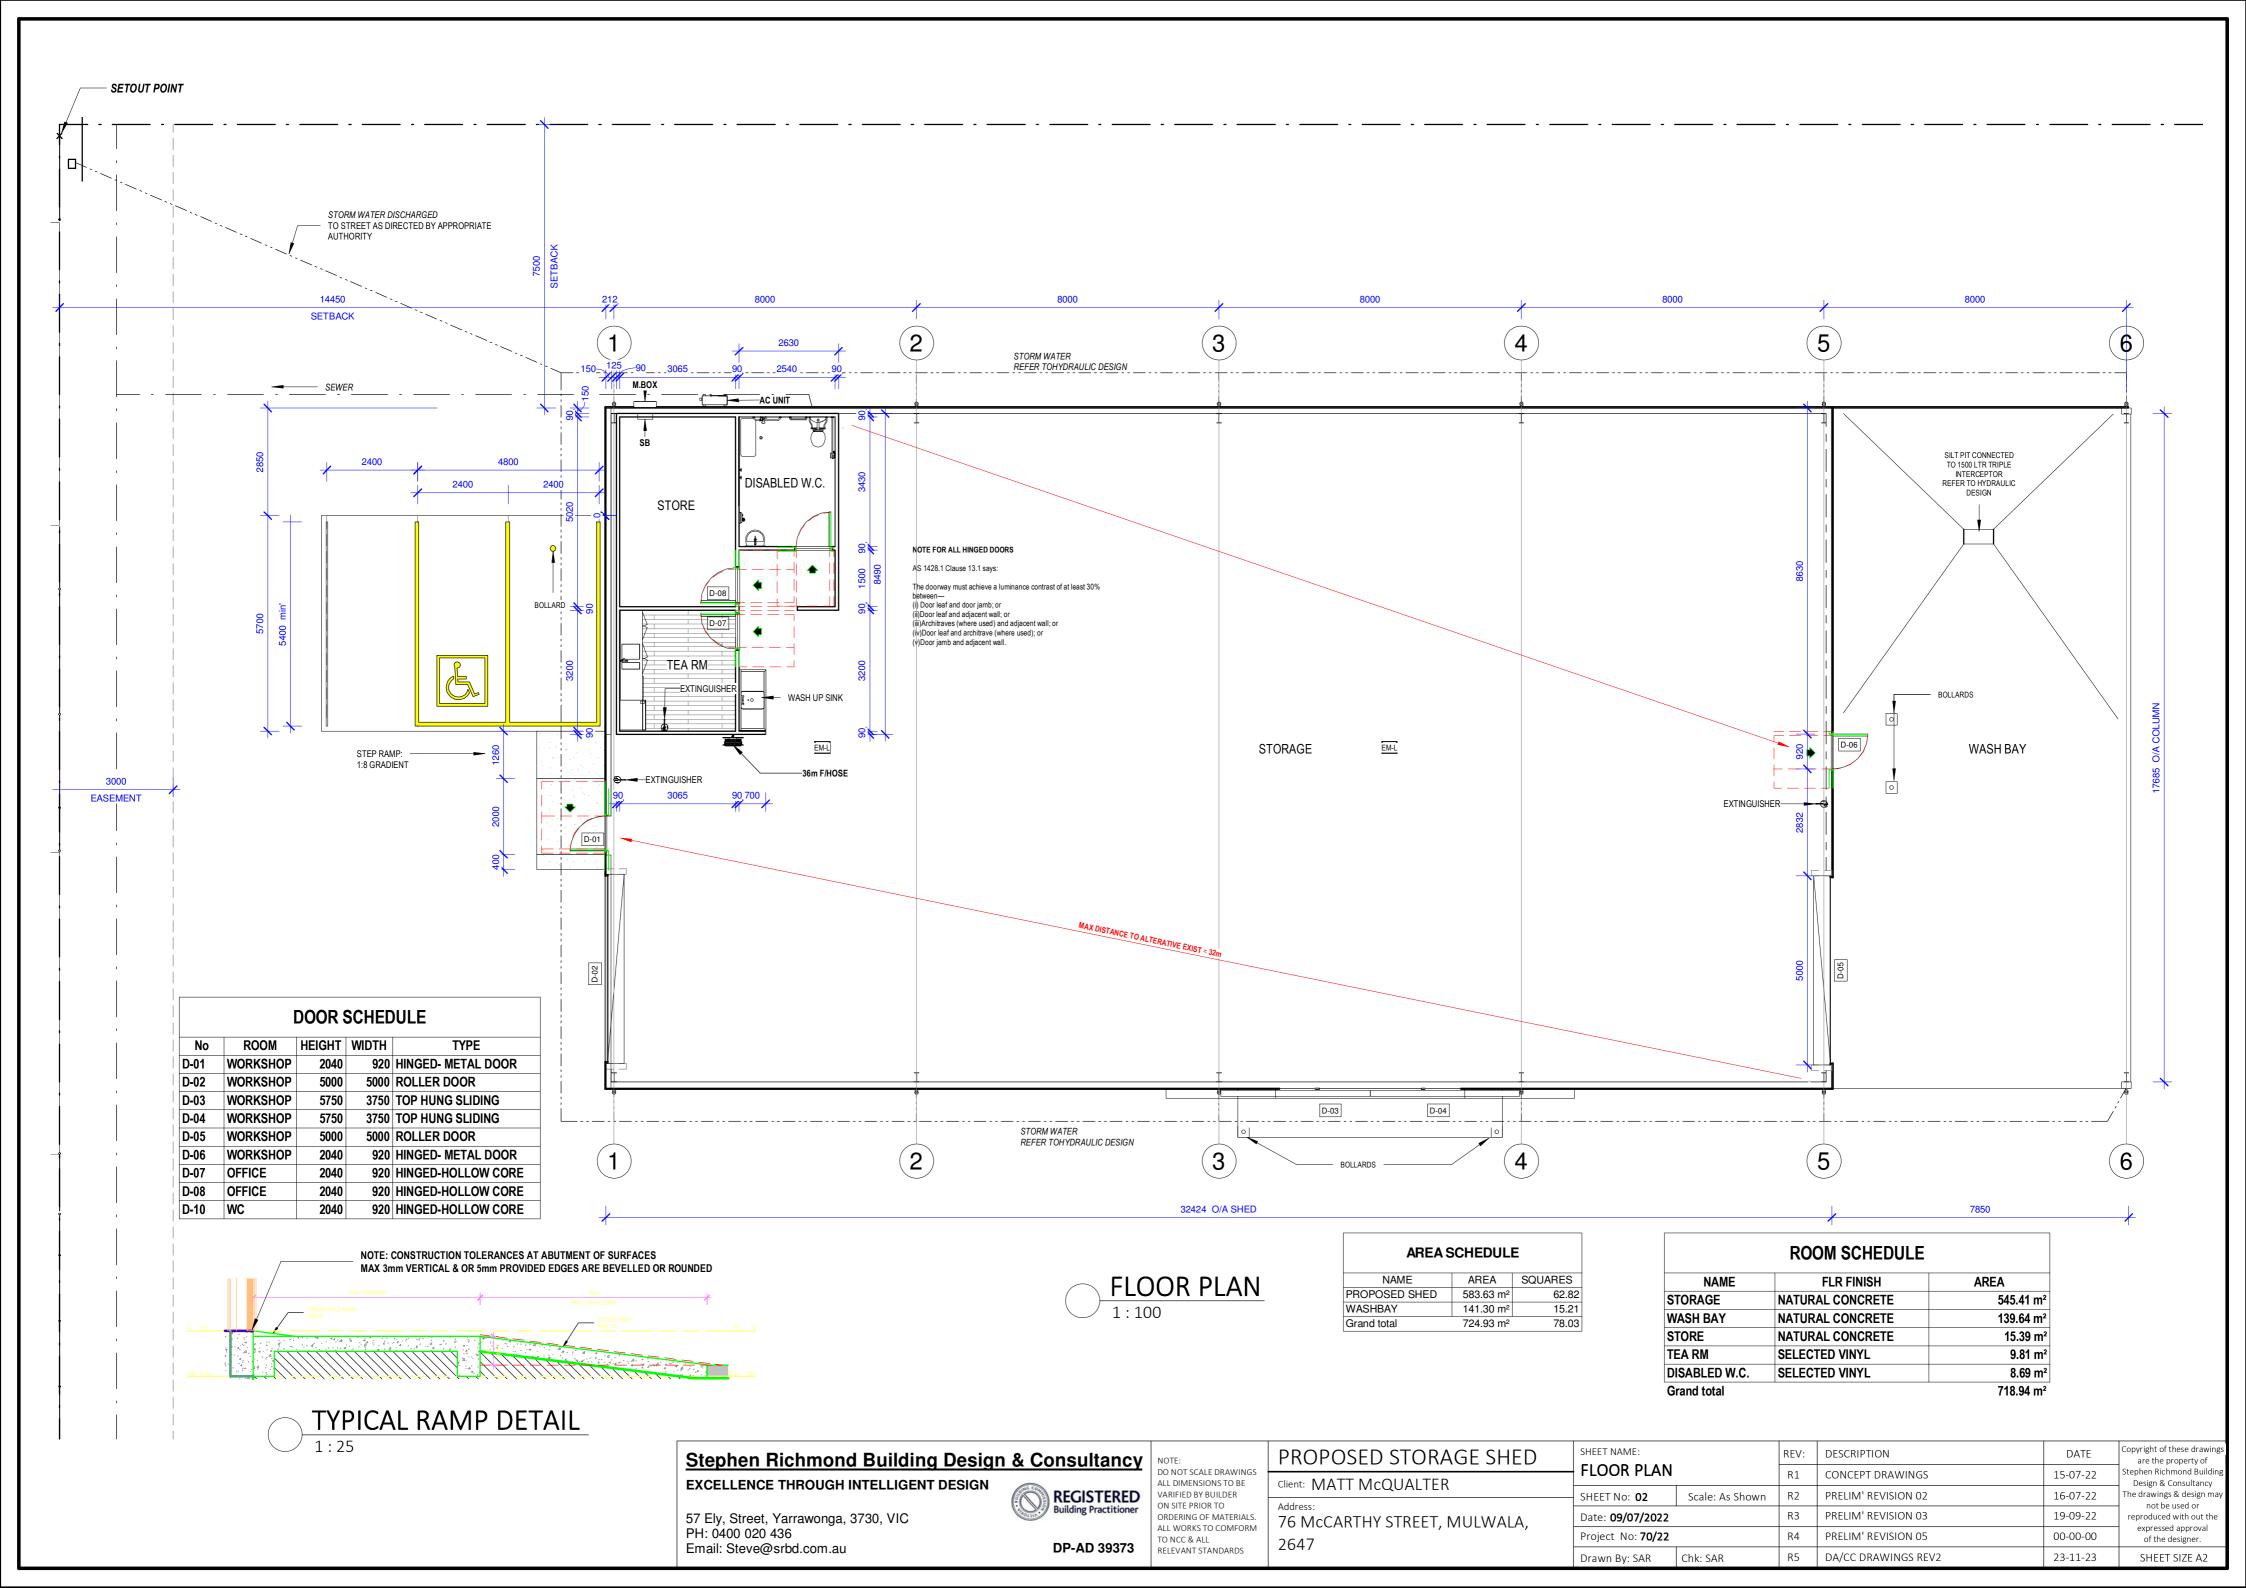

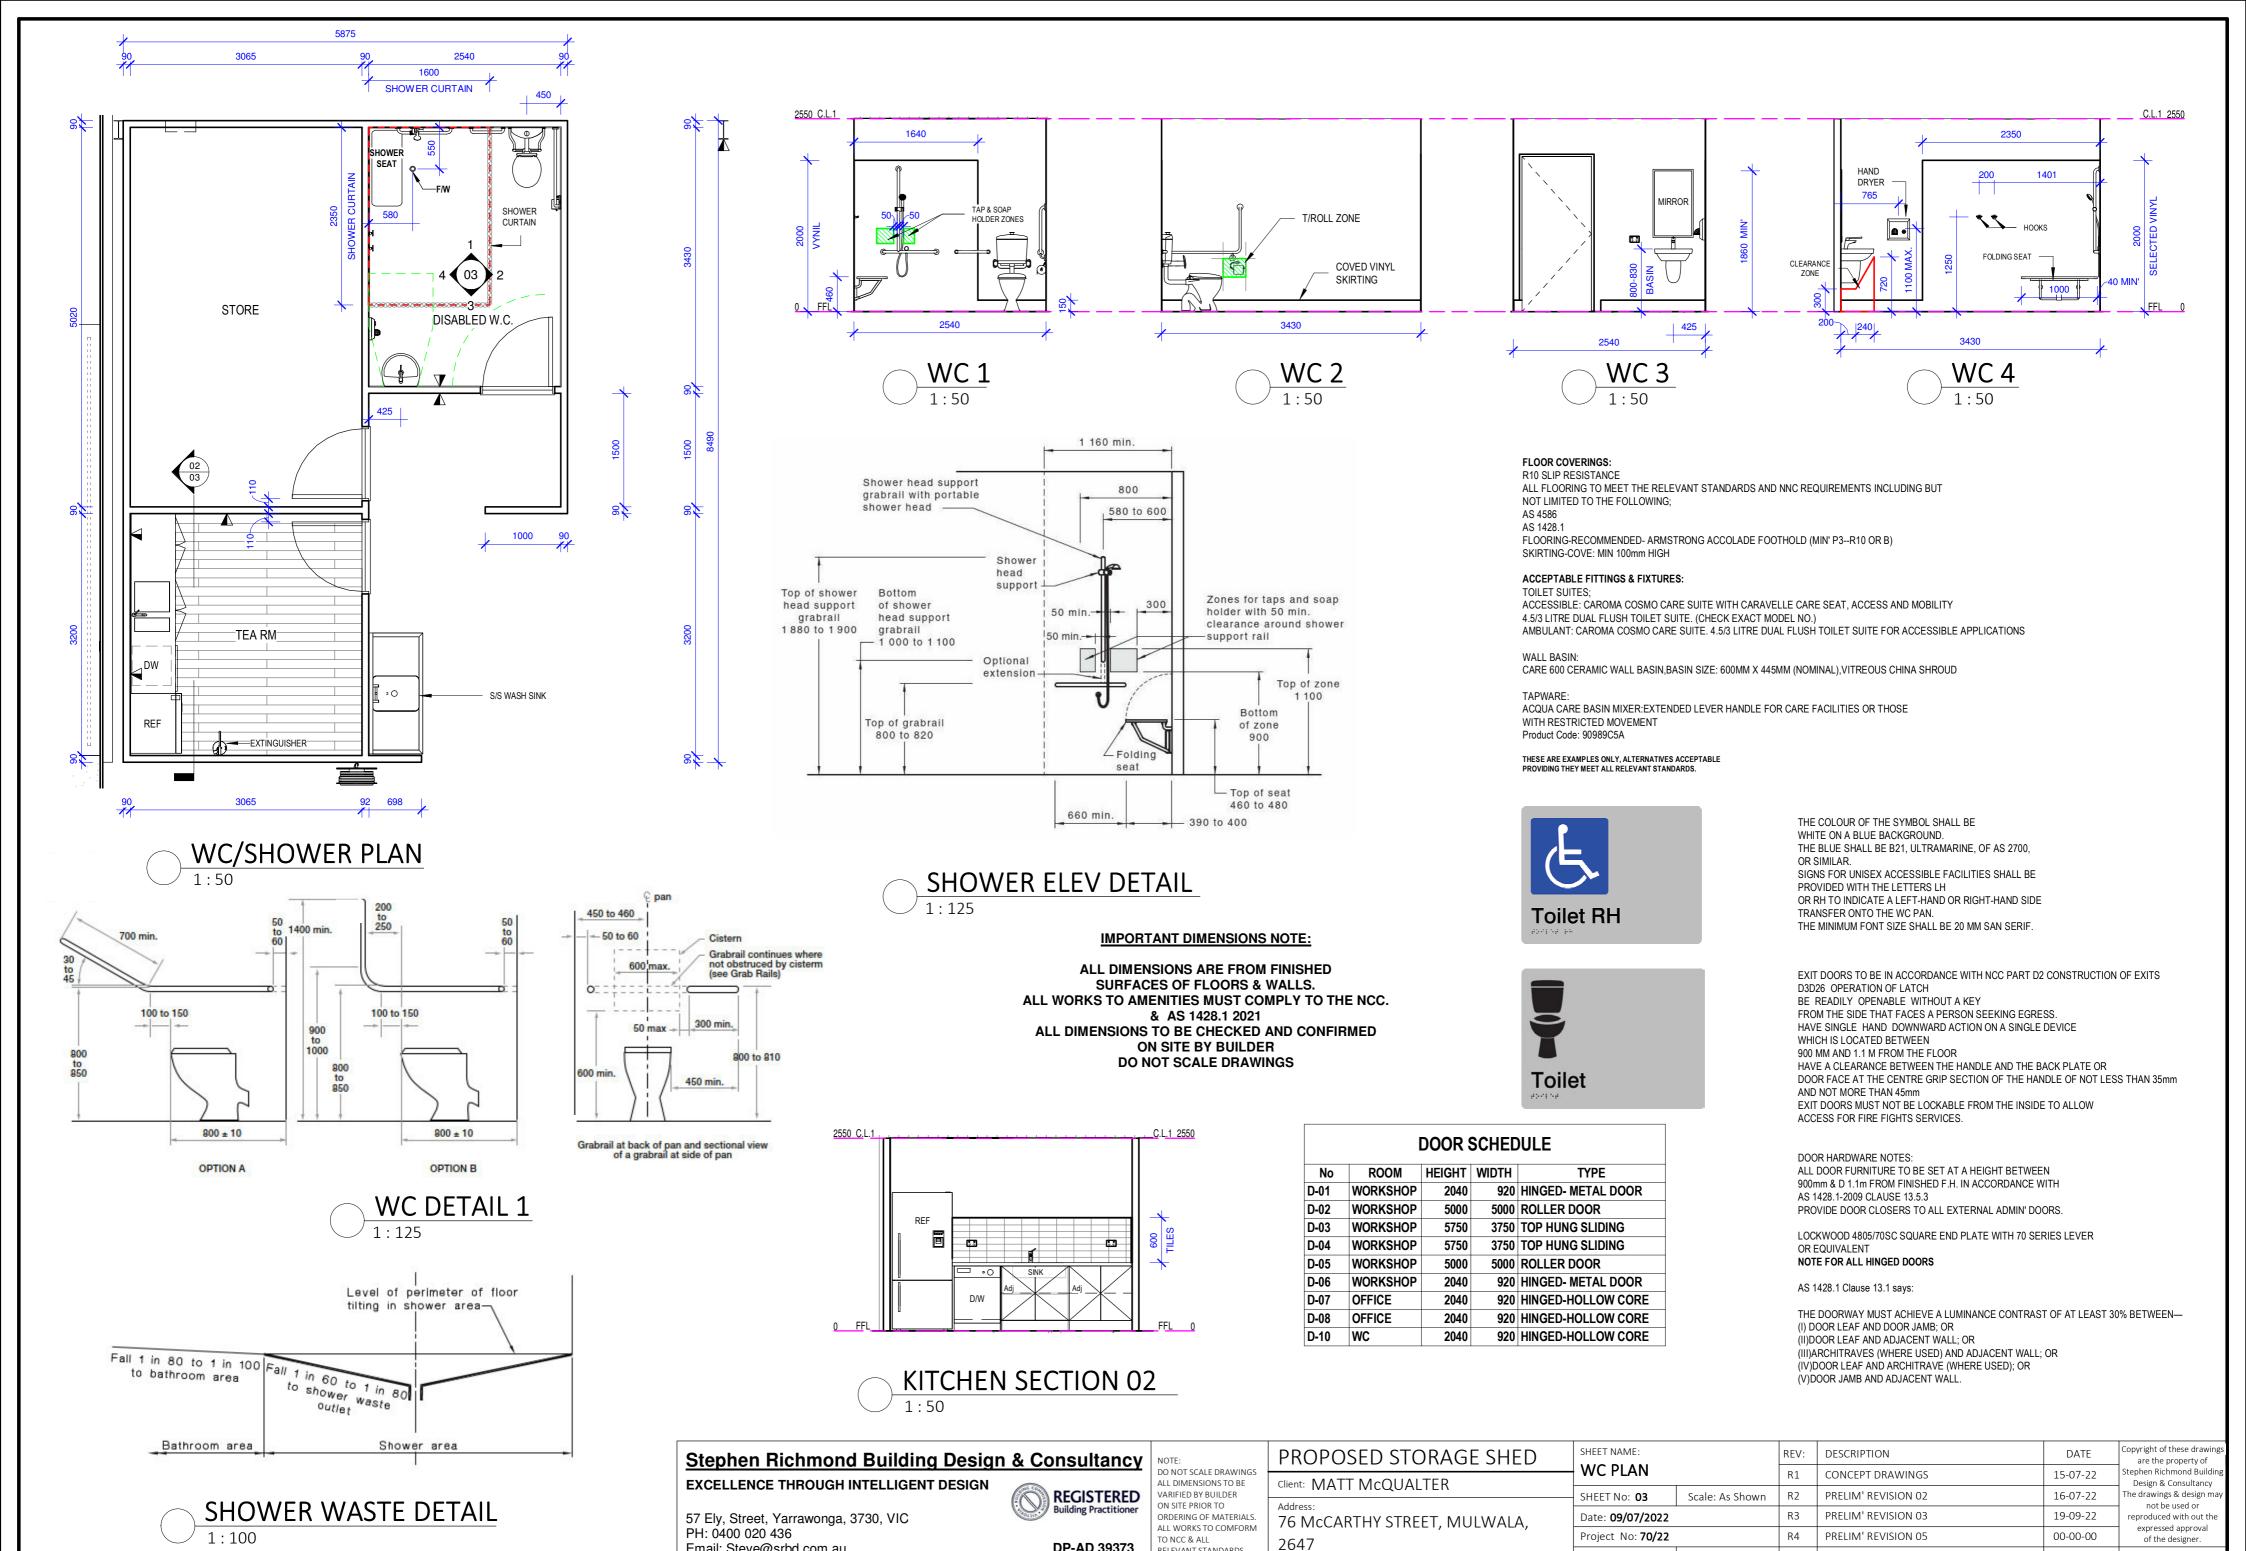

DP-AD 39373

RELEVANT STANDARDS

Drawn By: SAR


Chk: SAR


R5 DA/CC DRAWINGS REV2

23-11-23

SHEET SIZE A2

Email: Steve@srbd.com.au

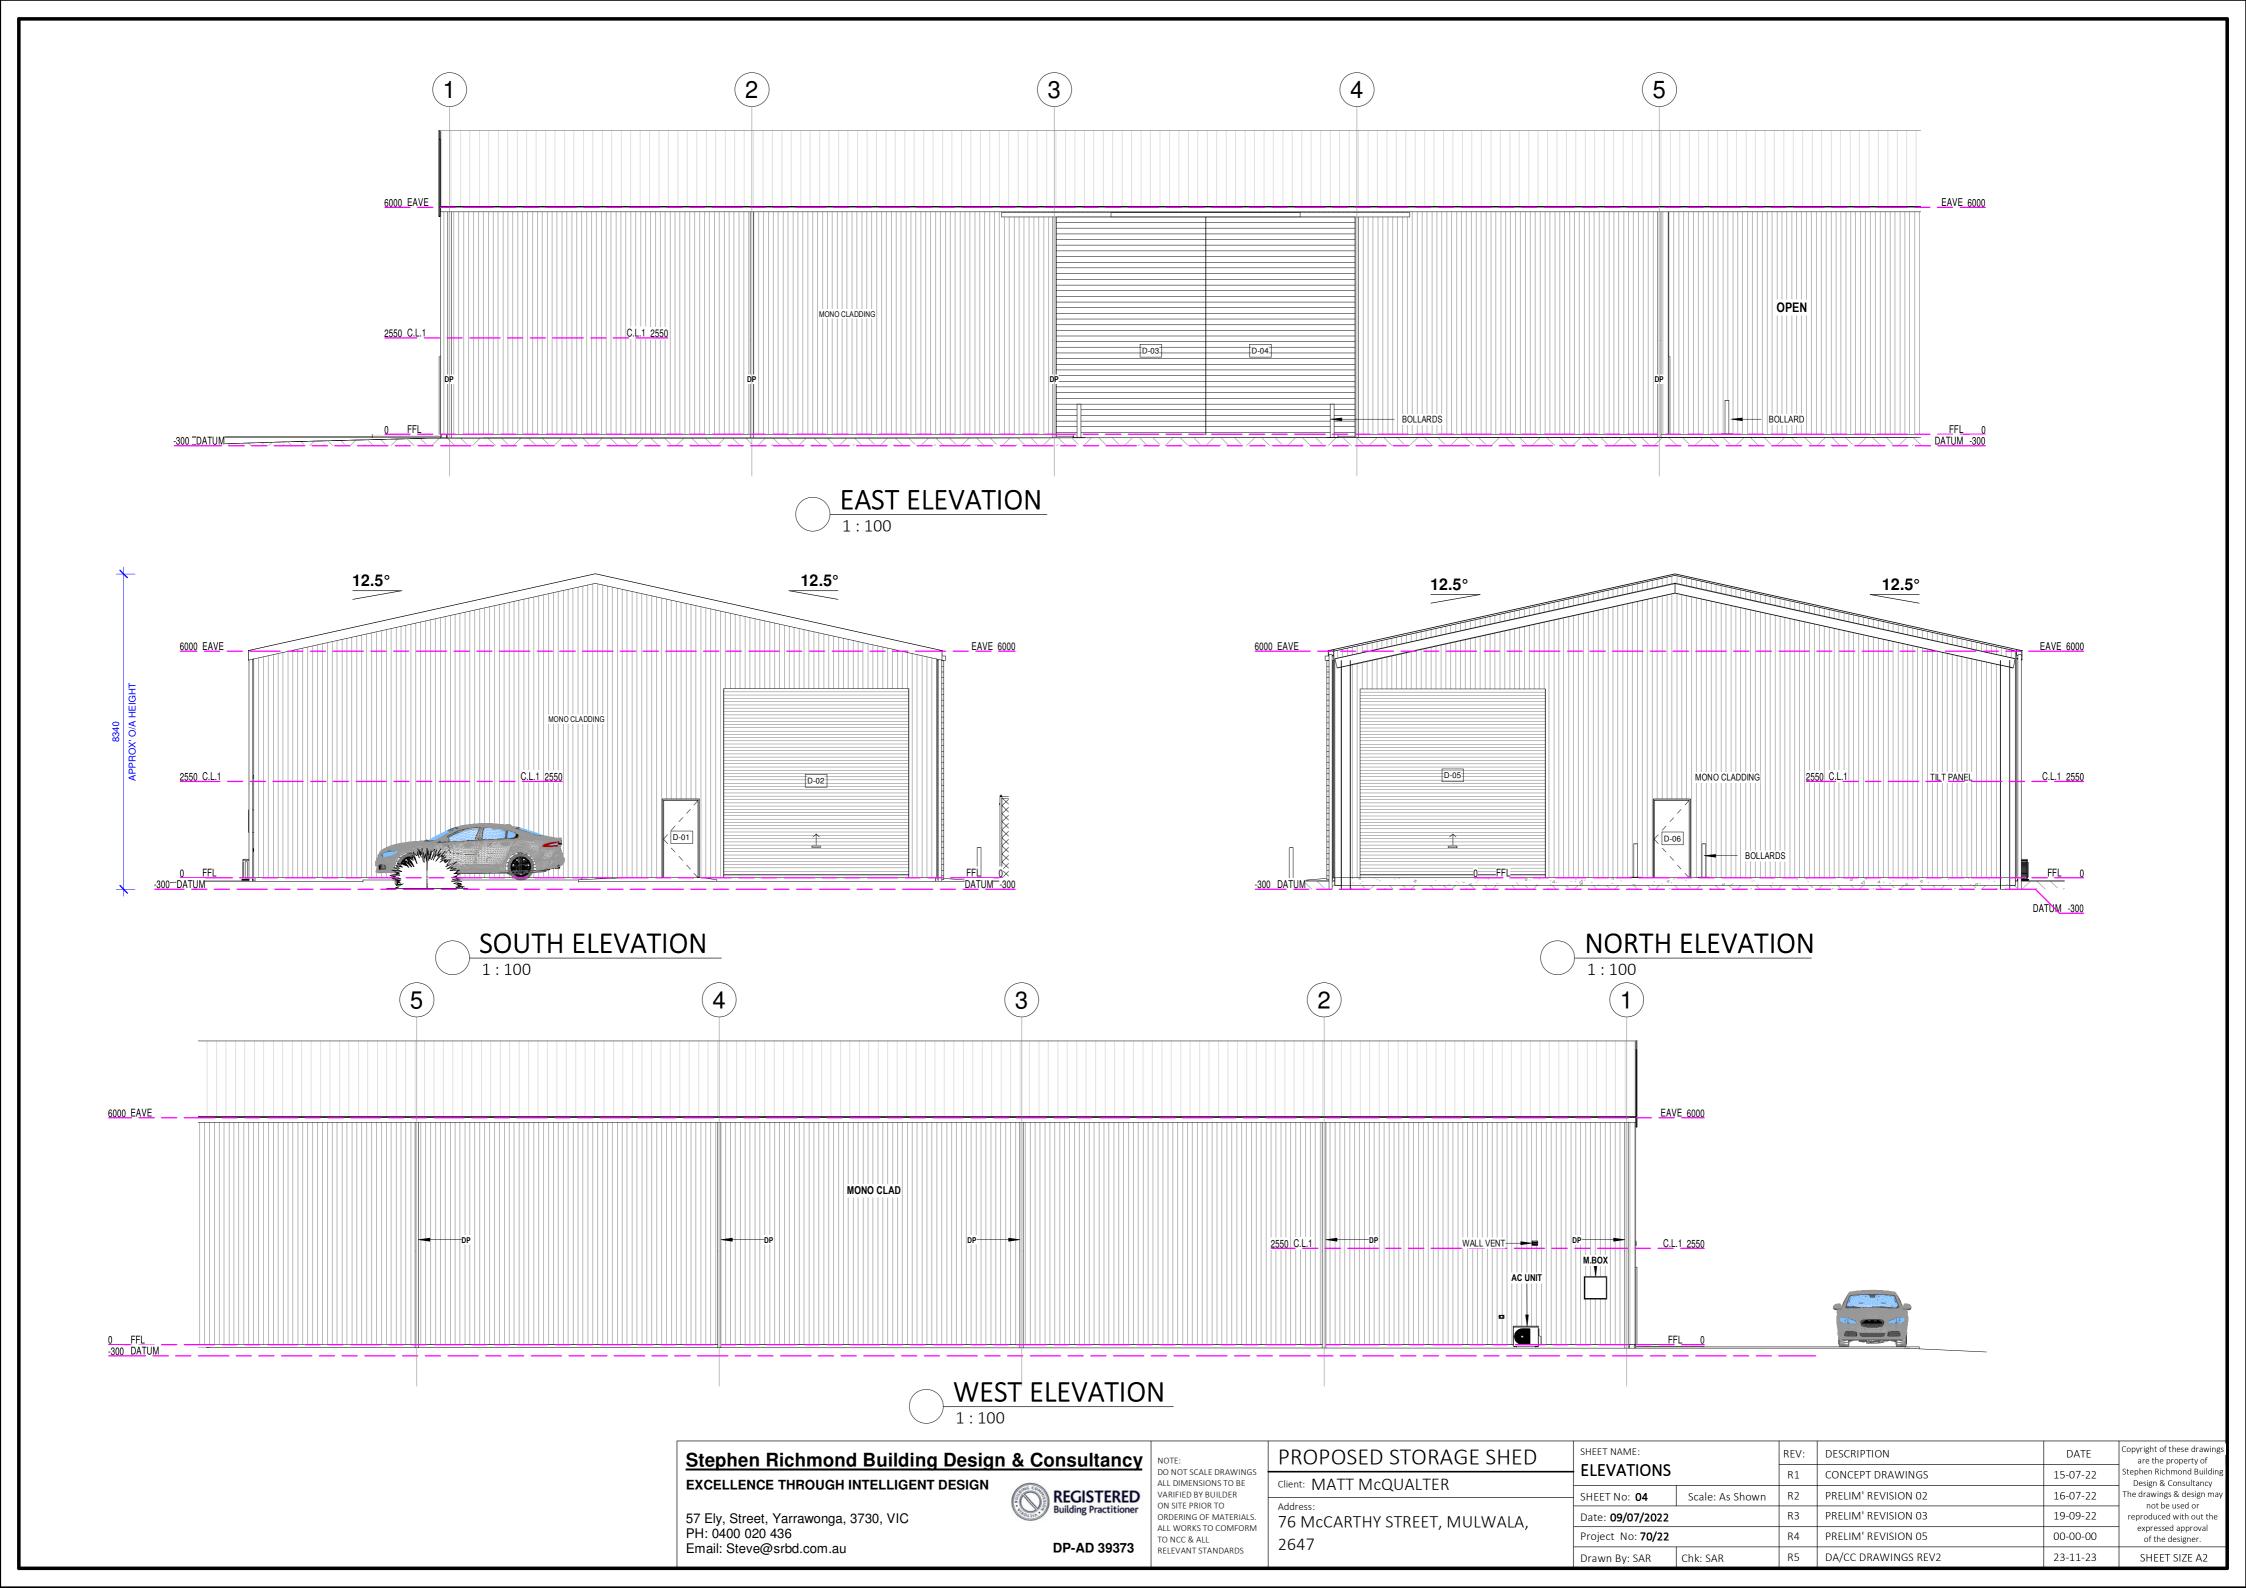

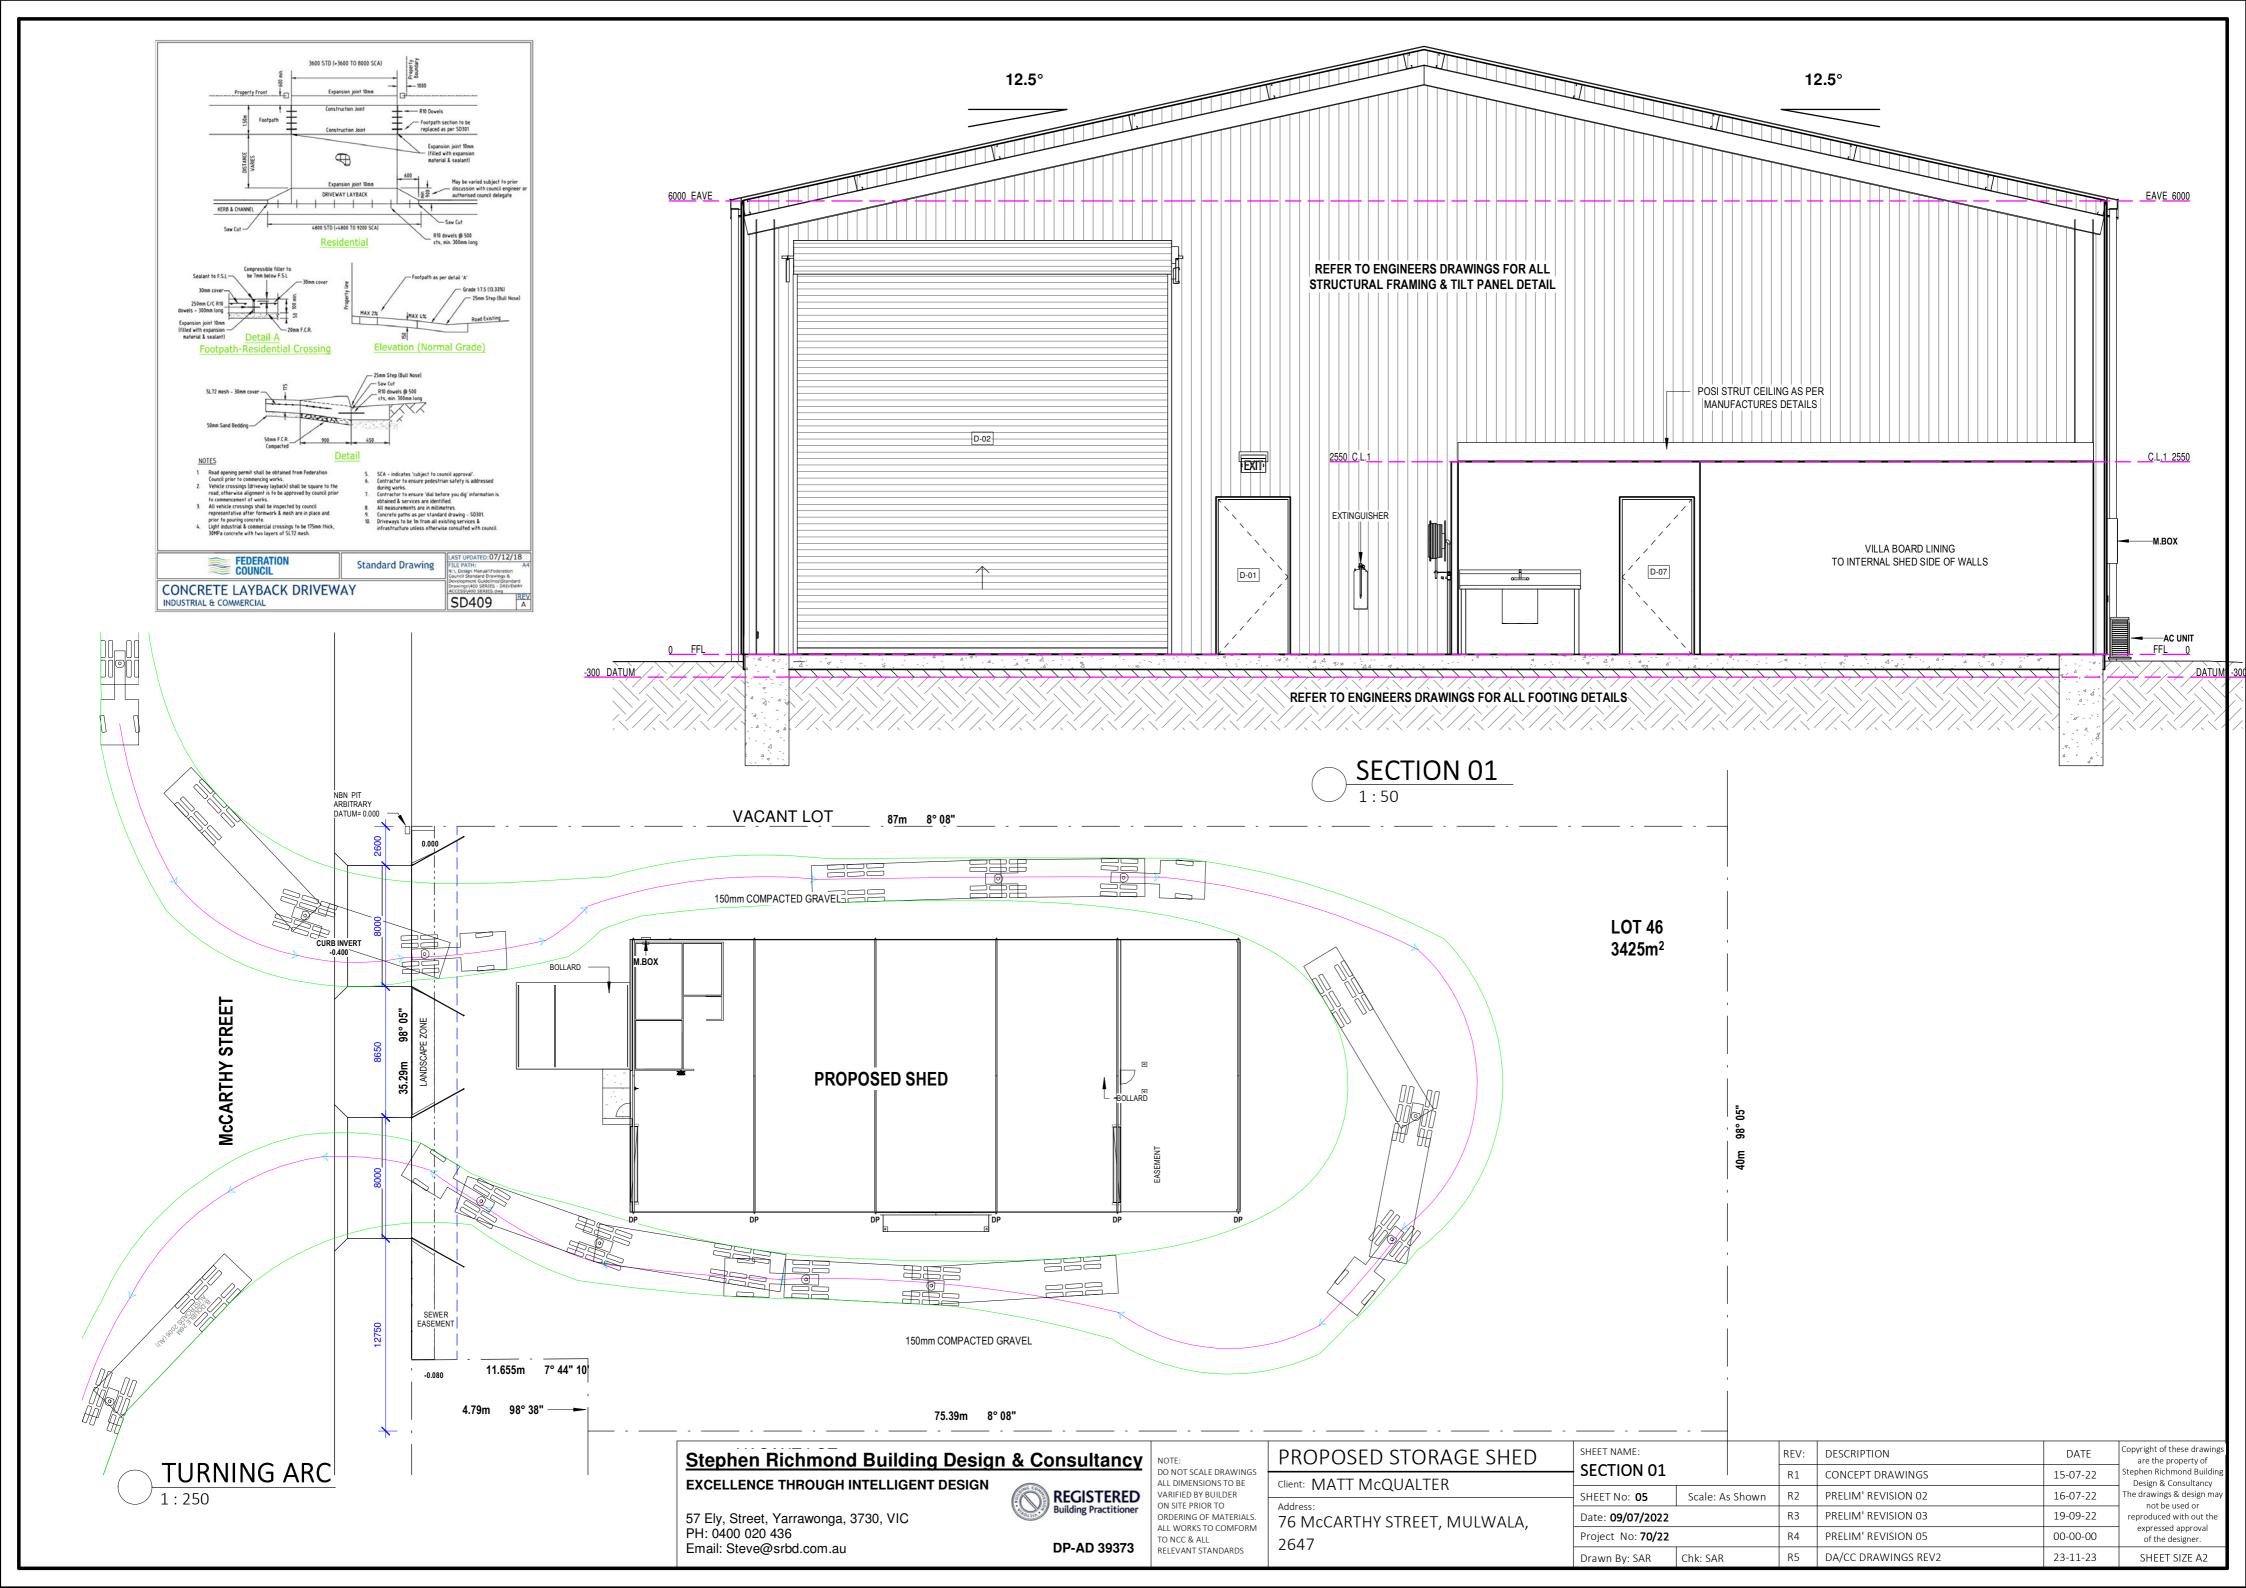

(a)	COMMERCIAL LED PENDANT LIGHT	Ī	FLOOD LIGHT	A	DOUBLE GPO	P	TELEPHONE POINT	AC	INTERNAL SPLIT SYSTEM UNIT	-	\rightarrow	RETURN AIR LOCATION		ELECTRIC HOT WATER SERVICE
● DL	DOWN LIGHT	Î	MOTION SENSOR	∇	SINGLE GPO	<u>T</u>	DOUBLE EXTERNAL GPO		CEILING FAN	O FAN	1	THERMOSTAT		EVAPORATIVE AIR
	DOUBLE FLUORESCENT GLOBE	•	EXHAUST FAN (DAMPER)	\otimes	ISOLATION SWITCH	∇	SINGLE EXTERNAL GPO		WITH LIGHT CEILIN	G FAN	-BJ	GAS METER		CONDITIONER
0	SINGLE FLUORESCENT GLOBE	0,0	4 GLOBE IXL	<u>s</u>	SMOKE DETECTOR	\Box	A/C OUTLET	Θ	DUCTED HEATING OUTLET		и.вох	ELECTRICITY METER		RAINWATER TANK PUMP
=	EXTERNAL WALL LIGHT		EMERGENCY EXIT LIGHT	(V)	TELEVISION POINT		EXTERNAL SPLIT SYSTEM UNIT	RA	RETURN AIR DUCT	1 1	HWS	GAS HOT WATER SERVICE	\otimes	DUCTED VACUUM UNIT
0	LED DOWN LIGHT	EM-L	EMERGENCY LIGHTING						GAS BOOSTED H/W			SWITCH BOARD	V	VACUUM OUTLET
MANHOLE LOCATION IS APPROXIMATE ONLY.														

NOTES:

EXACT POSITION WILL DEPEND ON TRUSS LAYOUT

ELECTRICAL LEGEND

ELECTRICAL FIXTURE SCHEDULE						
DESCRIPTION	No					
11 WATT LED DOWN LIGHT	4					
AC UNIT	1					
COMMERCIAL LED PENDANT LIGHT	3					
DBL LED FLOOD LIGHT	4					
DOUBLE GPO	14					
EMERGENCY LIGHT	2					
EXIT LIGHTING	2					
EXTERNAL DOUBLE GPO	1					
SHUTTERED EXHAUST FAN	2					

GENERAL ELECTRICAL NOTES ALL LIGHT POINTS WILL BE CENTRALLY LOCATED IN CEILINGS UNLESS SPECIFICALLY REQUESTED BY OTHERS - CONFIRM WITH OWNERS. THE POSITIONS OF DOWNLIGHTS WILL BE AS CLOSE AS POSSIBLE TO THE REQUESTED POSITION, HOWEVER IT IS SUBJECT TO THE POSITION OF ROOF TRUSSES AND OTHER INSTALLATIONS IN THE CEILING POINTS - CONFIRM WITH OWNER. WHERE REQUIRED, PROVIDE POWER FOR RANGEHOOD, HOT PLATES, DISHWASHER, WALL/UNDER BENCH OVEN, MICROWAVE, REFRIGERATOR, EVAPORATIVE COOLING UNIT, HEATING UNIT, GARAGE DOOR & HOT WATER SERVICE.

ARTIFICIAL LIGHTING

J7D3 ARTIFICIAL LIGHTING

NCC VOLUME ONE Part J7D3, Part E4 & Table J7D3a MAXIMUM ILLUMINATION POWER DENSITY J7D6 EXTERIOR ARTIFICIAL LIGHTING

ARTIFICIAL LIGHTING AROUND THE PERIMETER OF A BUILDING MUST BE

(A) BE CONTROLLED BY-

(I) A DAYLIGHT SENSOR; OR

(II) A TIME SWITCH THAT IS CAPABLE OF SWITCHING ON AND OFF ELECTRIC POWER TO THE SYSTEM AT VARIABLE PRE-PROGRAMMED

TIMES AND ON VARIABLE PRE-PROGRAMMED DAYS; AND

(B) WHEN THE TOTAL LIGHTING LOAD EXCEEDS 100 W-

(I) USE LED LUMINAIRES FOR 90% OF THE TOTAL LIGHTING LOAD; OR

(II) BE CONTROLLED BY A MOTION DETECTOR IN ACCORDANCE WITH SPECIFICATION 40; OR (III) WHEN USED FOR DECORATIVE PURPOSES, SUCH AS FAÇADE LIGHTING OR SIGNAGE LIGHTING,

HAVE A SEPARATE TIME SWITCH IN ACCORDANCE WITH SPECIFICATION 40. THE OVERALL LAMP POWER DENSITY MUST NOT EXCEED THE PRESCRIBED

ALLOWANCES AS PER ELECTRICAL PLAN FOR EACH AREA. HALOGEN LAMPS

MUST BE SEPARATELY SWITCHED FROM FLUORESCENT LAMPS

LIGHTING INSTALLED IN ADDITION TO THE PROPOSED INSTALLATION MUST NOT

EXCEED THE CALCULATED MAXIMUM WATTAGE AND MAY IMPACT ON

CEILING INSULATION -CONFIRM WITH BUILDING SURVEYOR ALL LIGHT FITTINGS & LAMPS SHOWN ARE ENERGY

EFFICIENT. ANY CHANGE TO NUMBER OF, OR LAMP ENERGY OUTPUT MUST BE

RE-EVALUATED FOR OVERALL COMPLIANCE OF NCC/BCA PART 3.12.5.4.

ALL INTERNAL LIGHTS ARE SURFACE MOUNTED UNLESS OTHERWISE NOTED. NOTE: THE R VALUE OF THE CEILING INSULATION MUST BE INCREASED WHERE CEILING INSULATION IS REMOVED AROUND DOWN LIGHTS AND EXHAUST FANS AS

USE INDUSTRY APPROVED DOWNLIGHT COVERS FOR INSULATION PROTECTION AND DRAFT SEALING (EXAMPLE: IGLOO RECESSED DOWNLIGHT COVER)

F6D6 VENTILATION OF ROOMS

SUPPLY AND INSTALL MECHICAL VENTILATION WHERE SHOWN TO COMPLY WITH AS 1668.2 & AS/NZS 3666.1

F8D4 EXHAUST SYSTEMS

MECHANICAL EXHAUSTS (25L/S) ARE REQUIRED IN THE SANITARY FACILITY ROOMS DISCHARGING DIRECTLY TO THE OUTSIDE VIA A DUCT OR ALTERNATIVE PIPING ALL MECHANICAL EXHAUSTS SHALL BE FITTED WITH SELF-CLOSING LOUVRED


FIRE EXTINGUISHER TO BE PLACED NO MORE THAN 20M APART

REGISTERS WHERE EXITING THE BUILDING.





TYPE: 4.5KG ABC INSTALLED IN ACCORDANCE WITH SECTION 3 OF AS 2444. FIRE EXTINGUISHERS SHOULD BE MOUNTED NO MORE THAN 1,200 MM, FROM THE FLOOR. LOCATION SIGN INSTALLED ABOVE THE EXTINGUISHER NOT LESS THAN 2 M ABOVE THE FLOOR, OR AT A HEIGHT THAT ENSURES THE SIGN IS VISIBLE LOCATION AND DISPLAY OF SIGN MIN - 2000MM ABOVE FLOOR LEVEL. A MINIMUM OF ONE SIGN MUST BE PROVIDED ABOVE OR ADJACENT TO AN EXTINGUISHER THE EXTINGUISHER AND FIRE POINT LOCATION SIGNS SHALL HAVE A SYMBOL, BORDER AND LETTERS IN WHITE ON A RED FIELD, COMPLYING WITH AUSTRALIAN STANDARD (AS) 2700.

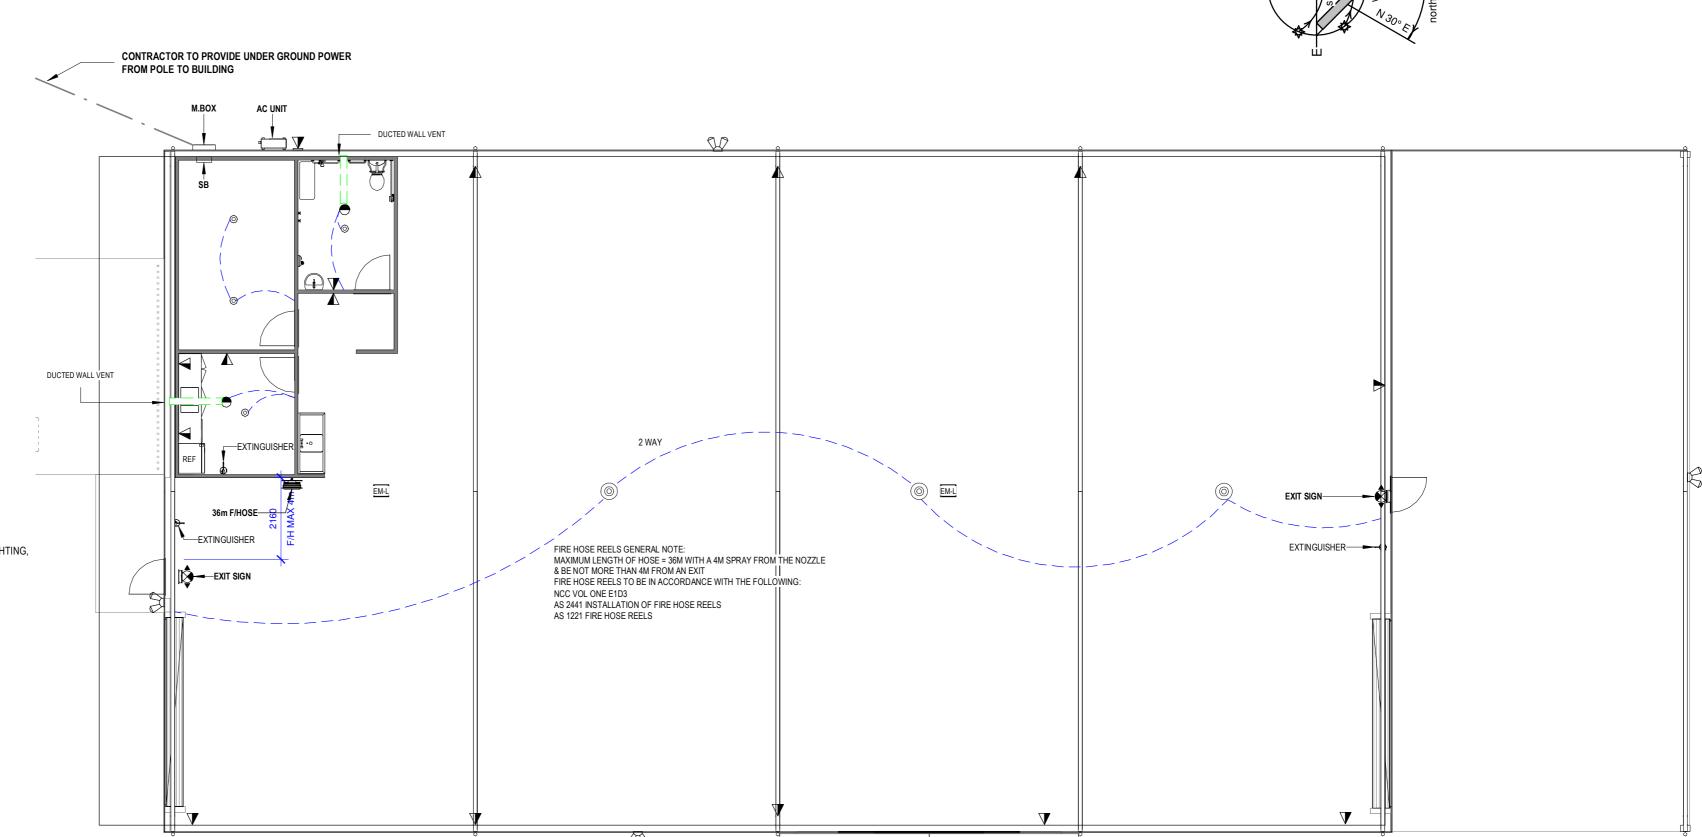

ELEC/LIGHTING PLAN

2647

NOTE: CONTRACT TO SUPPLY 3PHASE POWER FOR HYDRAULIC ELECTRICAL REQUIREMENTS REFER TO HYDRAULIC DESIGN BY OTHERS

Stephen Richmond Building Design & Consultancy NOTE:

EXCELLENCE THROUGH INTELLIGENT DESIGN 57 Ely, Street, Yarrawonga, 3730, VIC PH: 0400 020 436

Email: Steve@srbd.com.au



DP-AD 39373

DO NOT SCALE DRAWINGS ALL DIMENSIONS TO BE VARIFIED BY BUILDER ON SITE PRIOR TO ORDERING OF MATERIALS. ALL WORKS TO COMFORM TO NCC & ALL RELEVANT STANDARDS

PROPOSED STORAGE SHED Client: MATT McQUALTER

76 McCarthy Street, Mulwala,

Copyright of these drawing SHEET NAME: REV: DESCRIPTION are the property of **ELEC/LIGHTING PLAN** R1 CONCEPT DRAWINGS 15-07-22 Design & Consultancy SHEET No: 06 Scale: As Shown R2 PRELIM' REVISION 02 16-07-22 he drawings & design ma not be used or R3 PRELIM' REVISION 03 19-09-22 Date: 09/07/2022 reproduced with out the expressed approval R4 PRELIM' REVISION 05 Project No: **70/22** 00-00-00 of the designer. Drawn By: SAR Chk: SAR R5 DA/CC DRAWINGS REV2 23-11-23 SHEET SIZE A2

SCHEDULE 1 TO THE PARKING OVERLAY ACCESSIBLE SHARED Number of car parking spaces to be provided CAR SPACE AREA OFFICE: 2.5 per 100sq m of gross leasable floor area APPROX' GROSS LEASABLE FLOOR AREA 230sq m= 6 CARPARKS REQUIRED FLEXIBLE BOLLARD 1300mm MIN. HEIGHT

SEE NOTES.

ACCESSIBLE CAR PARKING SPACES IN ACCORDANCE WITH AS2890.6

SPACE IDENTIFICATION

EACH DEDICATED SPACE SHALL BE IDENTIFIED BY MEANS OF A WHITE SYMBOL OF ACCESS IN ACCORDANCE WITH AS 1428.1 BETWEEN 800 MM AND 1000mm HIGH PLACED ON A BLUE RECTANGLE WITH NO SIDE MORE THAN 1200mm, PLACED AS A PAVEMENT MARKING IN THE CENTRE OF THE SPACE BETWEEN 500mm AND 600mm FROM ITS ENTRY PONT AS ILLUSTRATED

SPACE DELINEATION

PAVEMENT MARKINGS SPECIFIED IN ITEMS (A) AND (B) OF THIS CLAUSE SHALL BE YELLOW AND SHALL HAVE A SLIP RESISTANT SURFACE. RAISED PAVEMENT MARKERS SHALL NOT BE USED FOR SPACE DELINEATION.

PAVEMENT MARKING SHALL BE PROVIDED AS FOLLOWS: 1. LINEMARKING

1.1 DEDICATED PARKING SPACES SHALL BE OUTLINED WITH UNBROKEN LINES 80 TO 100 MM WIDE ON ALL SIDES EXCEPTING ANY SIDE DELINEATED BY A KERB, BARRIER OR WALL

2. SHARED AREAS SHALL BE MARKED AS FOLLOWS:

- 2.1 WALKWAYS WITHIN OR PARTLY WITHIN A SHARED AREA SHALL BE MARKED WITH UNBROKEN LONGITUDINAL LINES ON BOTH SIDES OF THE WALKWAY EXCEPTING ANY SIDE DELINEATED BY A KERB. BARRIER OR WALL
- 2.2 OVER VACANT NON-TRAFFICKED AREAS, WHICH MAY BE INTENTIONALLY OR UNINTENTIONALLY OBSTRUCTED (E.G BY UNINTENDED PARKING), SHALL BE OUTLINED WITH UNBROKEN LINES 80 TO 100 MM ON ALL SIDES EXCEPTING ANY SIDE DELINEATED BY A KERB, BARRIER OR WALL, AND MARKED WITH DIAGONAL STRIPES 150 TO 200 MM WIDE WITH SPACES 200 MM TO 300 MM BETWEEN STRIPES. THE STRIPES SHALL BE AT AN ANGLE OF 45+ 10 DEGREES TO THE SIDE OF THE SPACE
- RECOMMENDED AREA MARKINGS SHALL BE PLACED IN TRAFFICKED
- 2.4 ALL LINEMARKINGS MUST BE NON SLIP
- 3 BOLLARDS
- 3.1 MINIMUM HEIGHT 1300mm
- 3.2 RECOMMENDED COLOUR BLUE TO CONTRAST AGAINST YELLOW LINE MARKING 3.3 RECOMMENDED FLEXIBLE BOLLARDS TO REDUCE MOTOR VEHICLE DAMAGE





















Acer rubrum 'October Glory

Corvmbia ficifolia -Red Flowering Gum

All garden beds to be prepared and formed with a minimum 300mm depth of top soil and then covered with minimum 75mm of bark chip or 14mm pebble aggregate. Irrigation to be fully automated via 13mm netafim drip lines controlled with a Hunter Node controlling multiple solanoids.

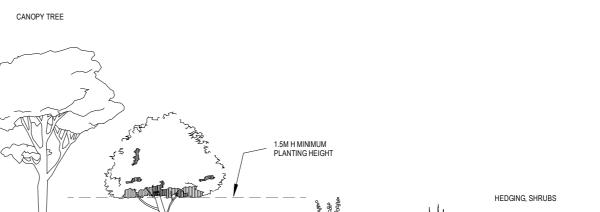

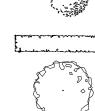


NATIVE GRASSES

SHRUB

HEDGING

1.5M H MINIMUM

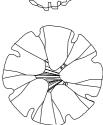

CANOPY TREE

GENERAL NOTES

ALL LEVELS ARE APPROXIMATE ONLY EXACT LEVELS TO BE CHECKED AND CONFIRMED ON SITE BY BUILDER

ALL DIMENSIONS TO BE CHECKED AND CONFIRMED ON SITE BY BUILDER DO NOT SCALE **DRAWINGS**

THESE DRAWINGS SHALL BE READ IN CONJUNCTION WITH ALL RELEVANT STRUCTURAL

ENGINEER, CIVIL ENGINEER AND ALL OTHER CONSULTANTS' DRAWINGS/DETAILS AND WITH ANY OTHER WRITTEN INSTRUCTIONS ISSUED IN THE COURSE OF THE CONTRACT

SURFACE DRAINAGE

THE EXTERNAL FINISHED SURFACE SURROUNDING THE SLAB MUST BE DRAINED TO MOVE SURFACE WATER AWAY FROM THE BUILDING AND GRADED TO GIVE A SLOPE OF NOT LESS THAN 50mm OVER THE FIRST 1m

INSTALLATION OF ALL SERVICES SHALL COMPLY WITH THE RESPECTIVE SUPPLY AUTHORITY REQUIREMENTS.

DO NOT SCALE PLANS, USE WRITTEN DIMENSIONS ONLY. FIGURED DIMENSIONS TAKE PRECEDENCE OVER SCALED DIMENSIONS. THE OWNER, BUILDER & SUBCONTRACTORS SHALL VERIFY ALL DIMENSIONS, LEVELS, SETBACKS AND SPECIFICATIONS PRIOR TO COMMENCING ANY WORKS OR ORDERING MATERIALS AND SHALL BE RESPONSIBLE FOR ENSURING THAT ALL BUILDING WORKS CONFORM TO THE BUILDING CODE OF AUSTRALIA, AS CODES (CURRENT EDITIONS), BUILDING REGULATIONS, LOCAL BY-LAWS AND TOWN PLANNING REQUIREMENTS. REPORT

THESE PLANS SHALL BE READ IN CONJUNCTION WITH ANY STRUCTURAL OR CIVIL ENGINEERING COMPUTATIONS AND DRAWINGS; AND ALL OTHER CONSULTANTS DRAWINGS / DETAILS AND WITH ANY OTHER WRITTEN INSTRUCTIONS ISSUED IN THE COURSE OF THE CONTRACT.

ALL DISCREPANCIES TO DESIGNER FOR CLARIFICATION.

UNLESS OTHERWISE SPECIFIED, COMPLY WITH THE REQUIREMENTS OF ALL

SPECIFIED STANDARDS AND CODES OF PRACTICE, INCLUSIVE OF BUT NOT LIMITED TO THE FOLLOWING:

AS NO. 1480 SAA CONCRETE STRUCTURES CODE AS NO. 1379 READY MIXED CONCRETE EXTERNAL WALLS PREFAB WALLS TO BE USED USING T2

REFER TO MANUFACTURERS DETAILS FOR SPECIFICATIONS & LAYOUT. EXT WALLS - R2.5 INSULATION TO ALL

EXTERNAL WALLS ALL INTERNAL NONE CONDITIONED WALLS TO HAVE R2

CARPENTRY

UNLESS OTHERWISE SPECIFIED, COMPLY WITH THE REQUIREMENTS OF ALL SPECIFIED STANDARDS AND CODES OF PRACTICE. INCLUSIVE OF BUT NOT LIMITED TO THE FOLLOWING; AS 1080 METHODS OF TEST FOR TIMBER - PART 1 -

NATIVE GRASSES

ROOF TRUSSES AT 900 CTRS. REFER TO MANUFACTURERS DETAILS FOR DESIGN SPECIFICATIONS & LAYOUT. R4.0 BATT INSULATION TO CEILINGS METAL CEILING BATTENS AT 450 CTRS 10mm PLASTERBOARD LINING TO CEILINGS. ROOF COVER COLORBOND ON METAL TOP HAT BATTENS AT 900 CTRS MAXIMUM. INSTALL SARKING UNDER SIDE OF ALL ROOFING COLORBOND RIDGE & HIP CAPPING & VALLEY FLASHING TO MATCH SELECTED ROOFING COLORBOND ROOFING - PITCH AS INDICATED SLOTTED COLORBOND GUTTERING FALL 1:400 TO SELECTED DOWN PIPES. COLORBOND FASCIA.

DOWNPIPES TO BE 90ø PVCU PIPE TO TANK. 100x50 COLORPBOND METAL FROM TANK EXHAUST FANS TO BE SELF CLOSING WEATHER STRIPPING TO EXTERNAL DOORS

AS 1684 SAA TIMBER FRAMING CODE AS 1748 MECHANICALLY STRESS-GRADED TIMBER AS 1490 VISUALLY STRESS GRADED RADIATA PINE FOR STRUCTURAL PURPOSES (METRIC UNITS)

LANDSCAPING

UNLESS OTHERWISE SPECIFIED, COMPLY WITH THE REQUIREMENTS OF ALL SPECIFIED STANDARDS AND CODES OF PRACTICE, INCLUSIVE OF

BUT NOT LIMITED TO THE FOLLOWING:

AS NO. 2588 GYPSUM PLASTERBOARD. AS NO. 2589 THE APPLICATION AND FINISHING OF GYPSUM

PLASTERBOARD IN FRAMED DWELLING CONSTRUCTION.

AS NO. 2592 GYPSUM PLASTER FOR BUILDING PURPOSES. ALL INTERNAL WALLS TO ENSUITE, LAUNDRY, BATHROOM AND WC TO HAVE MINIMUM R2.0 INSULATION ADDED

SANITARY/SEWAGE

SUPPLY AND INSTALL SANITARY SEWAGE TO COMPLY WITH AS 1260 & AS 3500

ARTIFICIAL LIGHTING SHALL COMPLY WITH AS 1680-1998 DOORS TO FULLY ENCLOSED SANITARY COMPARTMENTS SHALL COMPLY WITH THE FOLLOWING IF THERE IS NOT A CLEAR SPACE OF AT LEAST 1.2M BETWEEN CLOSET PAN AND NEAREST PART OF DOORWAY: OPEN OUTWARDS OR SLIDE OR BE READILY REMOVABLE FROM THE OUTSIDE OF THE SANITARY COMPARTMENT

UNLESS OTHERWISE SPECIFIED, COMPLY WITH THE REQUIREMENTS OF ALL RELEVANT STANDARDS, CODES OF PRACTICE, AND LOCAL AUTHORITY BY-LAWS.

SUPPLY AND INSTALL MECHICAL VENTILATION WHERE SHOWN TO COMPLY WITH AS 1668 MECHANICAL EXHAUSTS (25L/S) ARE REQUIRED IN THE SANITARY FACILITY ROOMS DISCHARGING DIRECTLY TO THE OUTSIDE VIA A DUCT OR ALTERNATIVE PIPING ALL MECHANICAL EXHAUSTS SHALL BE FITTED WITH SELF-CLOSING LOUVRED REGISTERS WHERE EXITING THE BUILDING.

WFT AREAS

WATERPROOF WET AREAS TO COMPLY WITH AS 3740-2004 AND BCA PART 3.8.1 WET AREAS ARE TO BE IMPERVIOUS TO WATER I.E. WALL SURFACES AND SUBSTRATES OF SHOWER ENCLOSURES, OR IF UNENCLOSED, WITHIN 1.5M HORIZONTALLY FROM THE FIXTURE AND TO A HEIGHT OF 1.8M ABOVE THE FLOOR; AND BEHIND ANY BATH, SINK ETC IF WITHIN 75MM OF A WALL TO A HEIGHT OF 150MM ABOVE THE FIXTURE

Stephen Richmond Building Design & Consultancy NOTE:

57 Ely, Street, Yarrawonga, 3730, VIC PH: 0400 020 436 Email: Steve@srbd.com.au

EXCELLENCE THROUGH INTELLIGENT DESIGN



ON SITE PRIOR TO TO NCC & ALL DP-AD 39373 RELEVANT STANDARDS

DO NOT SCALE DRAWINGS ALL DIMENSIONS TO BE VARIFIED BY BUILDER ORDERING OF MATERIALS. ALL WORKS TO COMFORM

PROPOSED STORAGE SHED

Client: MATT McQUALTER

76 McCarthy Street, Mulwala, 2647

SHEET NAME:		REV:	DESCRIPTION	DATE	Copyright of these drawing are the property of	
NOTES	I/I CONCLITIDIAWINGS IJ-07-22 1				Stephen Richmond Building Design & Consultancy	
SHEET No: 07 Scale: As Shown		R2	PRELIM' REVISION 02	16-07-22	The drawings & design may not be used or	
Date: 09/07/2022		R3 PRELIM' REVISION 03 19-09-22 repro		reproduced with out the		
Project No: 70/22		R4	PRELIM' REVISION 05	00-00-00	expressed approval of the designer.	
Drawn By: SAR	Chk: SAR	R5	DA/CC DRAWINGS REV2	23-11-23	SHEET SIZE A2	