

Pre-Lodgement Application Form

Applicant contact details

Title	Mr
First given name	WIII
Other given name/s	
Family name	McBurnie
Contact number	
Email	
Address	
Application on behalf of a company, business or body corporate	Yes
ABN	48095458503
ACN	095458503
Name	MCBURNIE GROUP PTY LTD
Trading name	MCBURNIE GROUP PTY LTD
Is the nominated company the applicant for this application	Yes

Owner/s of the development site

Owner/s of the development site	There are one or more owners of the development site and the applicant is NOT one of them
Owner#	1
Title	Mr
First given name	Darren
Other given name/s	
Family name	Pay
Contact number	
Email	
Address	

I declare that I have shown this document, including all attached drawings, to the owner(s) of the land, and that I have obtained their consent to submit this application. - Yes

Note: It is an offence under Section 10.6 of the Environmental Planning and Assessment Act 1979 to provide false or misleading information in relation to this application.

Site access details

which the	there any security or site conditions ch may impact the person undertaking inspection? For example, locked gates, mals etc.	Yes
Pro	vide details	Locked Gates

Developer details

ABN	48 095 458 503
ACN	095 458 503
Name	MCBURNIE GROUP PTY LTD
Trading name	MCBURNIE GROUP PTY LTD
Address	
Email Address	

Development details

Application type	Development Application
Site address #	1
Street address	55-57 DEFENCE DRIVE MULWALA 2647
Local government area	FEDERATION
Lot / Section Number / Plan	41/-/DP1257361
Primary address?	Yes
	Land Application LEP Corowa Local Environmental Plan 2012
	Land Zoning E4: General Industrial
	Height of Building 9 m
	Floor Space Ratio (n:1) NA
Planning controls affecting property	Minimum Lot Size NA
	Heritage NA
	Land Reservation Acquisition NA
	Foreshore Building Line NA

Proposed development

Selected common application types	Erection of a new structure
Selected development types	General industry
Description of development	Construction of second Class 7(B) Shed on property.
Provide the proposed hours of operation	
Proposed to operate 24 hours on Monday	No
Monday	
Proposed to operate 24 hours on Tuesday	No
Tuesday	
Proposed to operate 24 hours on Wednesday	No
Wednesday	
Proposed to operate 24 hours on Thursday	No
Thursday	_
Proposed to operate 24 hours on Friday	No
Friday	E)
Proposed to operate 24 hours on Saturday	
Saturday	F
Proposed to operate 24 hours on Sunday	
Sunday	₩
Dwelling count details	
Number of dwellings / units proposed	
Number of storeys proposed	
Number of pre-existing dwellings on site	
Number of dwellings to be demolished	
Number of proposed occupants	0
Existing gross floor area (m2)	288
Proposed gross floor area (m2)	336
Total site area (m2)	3,247
Total net lettable area (m2)	0

What is the estimated development cost, including GST?	\$151,000.00
Estimated development cost	\$151,000.00
Do you have one or more BASIX certificates?	
Climate Zone	
What climate zone/s is the development in?	Climate zone 8 - alpine
Has the climate zone impacted the design of the development?	No
Subdivision	
Number of existing lots	
Proposed operating details	
Number of additional jobs that are proposed to be generated through the operation of the development	1
Number of staff/employees on the site	1

Number of parking spaces

Number of loading bays	
Is a new road proposed?	No
Concept development	
Is the development to be staged?	No, this application is not for concept or staged development.
Crown development	
Is this a proposed Crown development?	No

Related planning information

Is the application for integrated	No
development? Is your proposal categorised as designated	
development?	No
Is your proposal likely to significantly impact on threatened species, populations, ecological communities or their habitats, or is it located on land identified as critical habitat?	No
Is this application for biodiversity compliant development?	Yes
What are the reasons the development is biodiversity compliant development?	
Is this application subject to a private land conservation agreement under the Biodiversity Conservation Act 2016?	No
Does the application propose a variation to a development standard in an environmental planning instrument (eg LEP or SEPP)?	No
Is the application accompanied by a Planning Agreement ?	No
Section 68 of the Local Government Act	
Is approval under s68 of the Local Government Act 1993 required?	No
10.7 Certificate	
Have you already obtained a 10.7 certificate?	

Tree works	
Is tree removal and/or pruning work proposed?	No
Local heritage	
Does the development site include an item of environmental heritage or sit within a heritage conservation area.	No
Are works proposed to any heritage listed buildings?	No
Is heritage tree removal proposed?	No
Affiliations and Pecuniary interests	
Is the applicant or owner a staff member or councillor of the council assessing the application?	No
Does the applicant or owner have a relationship with any staff or councillor of the council assessing the application?	No
Political Donations	
Are you aware of any person who has financial interest in the application who has made a political donation or gift in the last two years?	No
Please provide details of each donation/gift which has been made within the last 2 years	

Sustainable Buildings

Is the development exempt from the <u>State</u> <u>Environmental Policy (Sustainable</u> <u>Buildings) 2022</u> Chapter 3, relating to non-residential buildings?	Yes
Provide reason for exemption. Is the development any of the following:	An alteration or addition with a Capital Investment Value under \$10 million, or a new development with a Capital Investment Value under \$5 million

Payer details

Provide the details of the person / entity that will make the fee payment for the assessment.

The Environmental Planning and Assessment Regulation 2021 and Council's adopted fees and charges establish how to calculate the fee payable for your development application. For development that involves building or other works, the fee for your application is based on the estimated cost of the development.

If your application is for integrated development or requires concurrence from a state agency, additional fees will be required. Other charges may be payable based on the Council's adopted fees and charges. If your development needs to be advertised, the Council may charge additional advertising fees. Once this application form is completed, it and the supporting documents will be submitted to the Council for lodgement, at which time the fees will be calculated. The Council will contact you to obtain payment. Note: When submitting documents via the NSW Planning Portal, credit card information should not be displayed on documents attached to your development application. The relevant consent authority will contact you to seek payment.

The application may be cancelled if the fees are not paid:


Company Name	McBurnie Group Pty Ltd
ABN	48 095 458 503
ACN	095 458 503
Trading Name	Fair Dinkum Builds Yarrawonga
Email address	
Billing address	


Application documents


The following documents support the application.

I confirm that the change(s) entered is/are made with appropriate authority from the applicant(s).


Document type	Document file name
Cost estimate report	PAN-430522 Cost Summary Report
Site Plans	55-57 Defence Drv construction drawings 12-04-24
Statement of environmental effects	PAN-430522 Environmental Effects
Applicant declarations	
I declare that all the information in my application and accompanying documents is , to the best of my knowledge, true and correct.	Yes
I understand that the development application and the accompanying information will be provided to the appropriate consent authority for the purposes of the assessment and determination of this development application.	Yes
I understand that if incomplete, the consent authority may request more information, which will result in delays to the application.	Yes
I understand that the consent authority may use the information and materials provided for notification and advertising purposes, and materials provided may be made available to the public for inspection at its Offices and on its website and/or the NSW Planning Portal	Yes
I acknowledge that copies of this application and supporting documentation may be provided to interested persons in accordance with the Government Information (Public Access) 2009 (NSW) (GIPA Act) under which it may be required to release information which you provide to it.	Yes
I agree to appropriately delegated assessment officers attending the site for the purpose of inspection.	Yes
I have read and agree to the collection and use of my personal information as outlined in the Privacy Notice	Yes

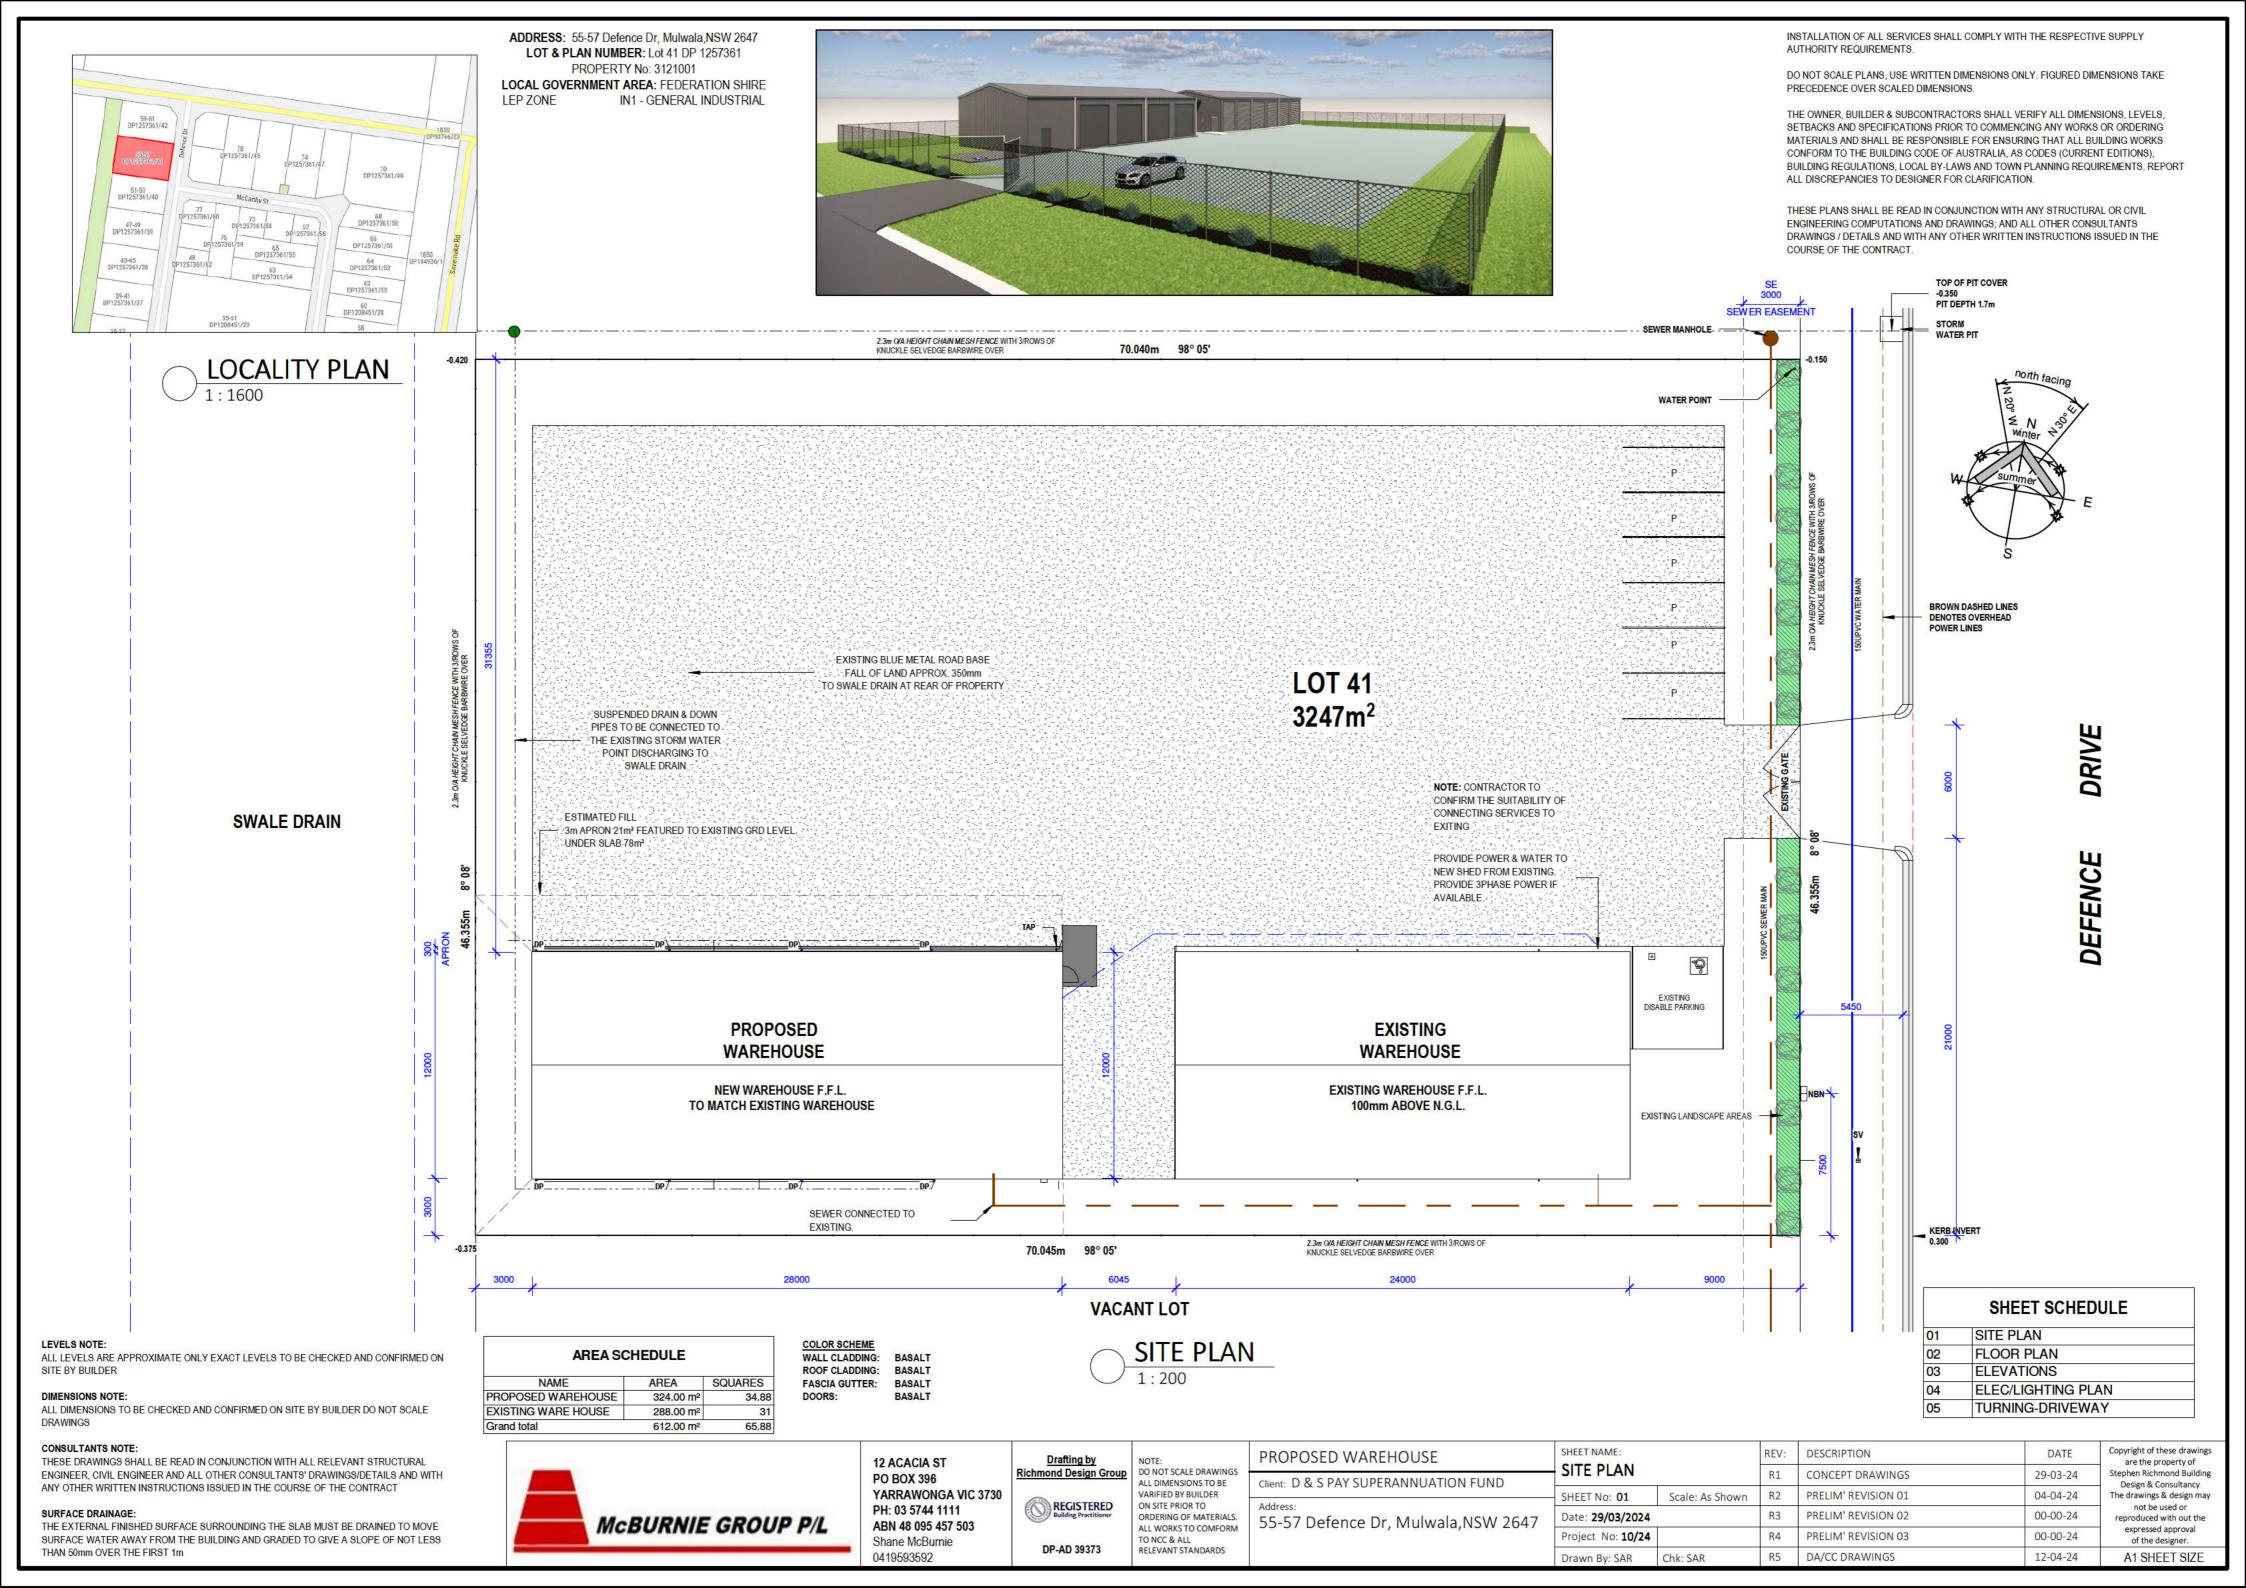

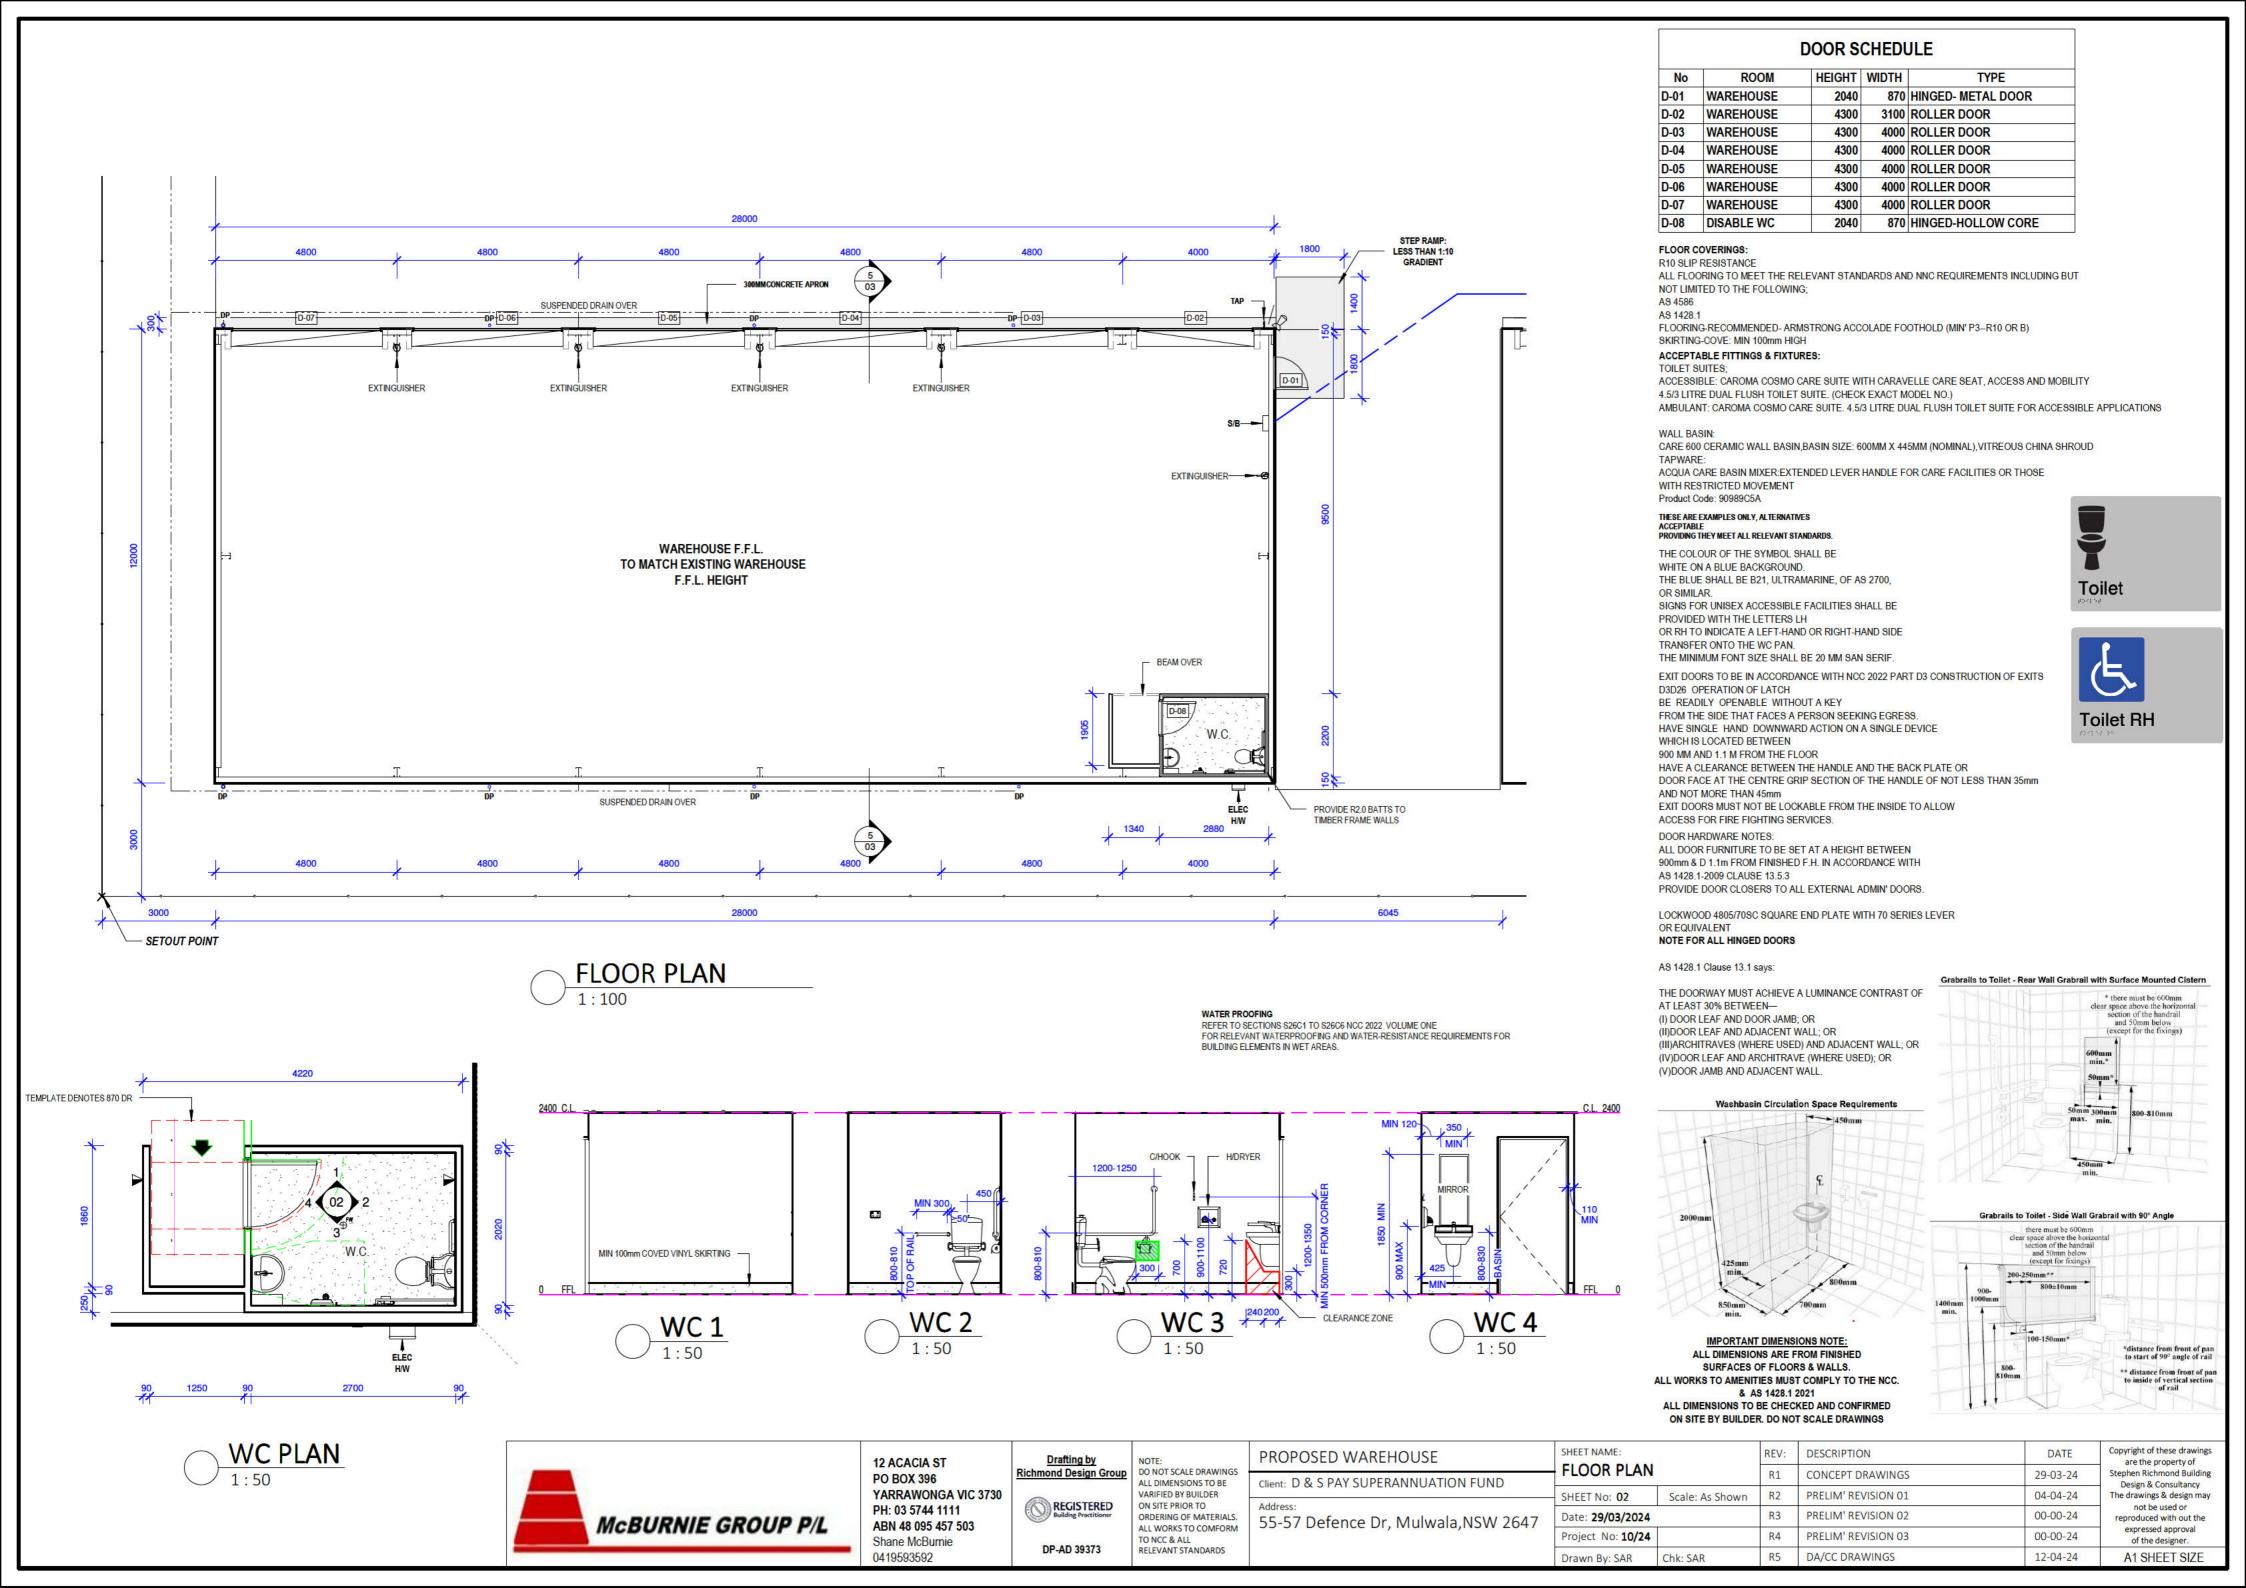

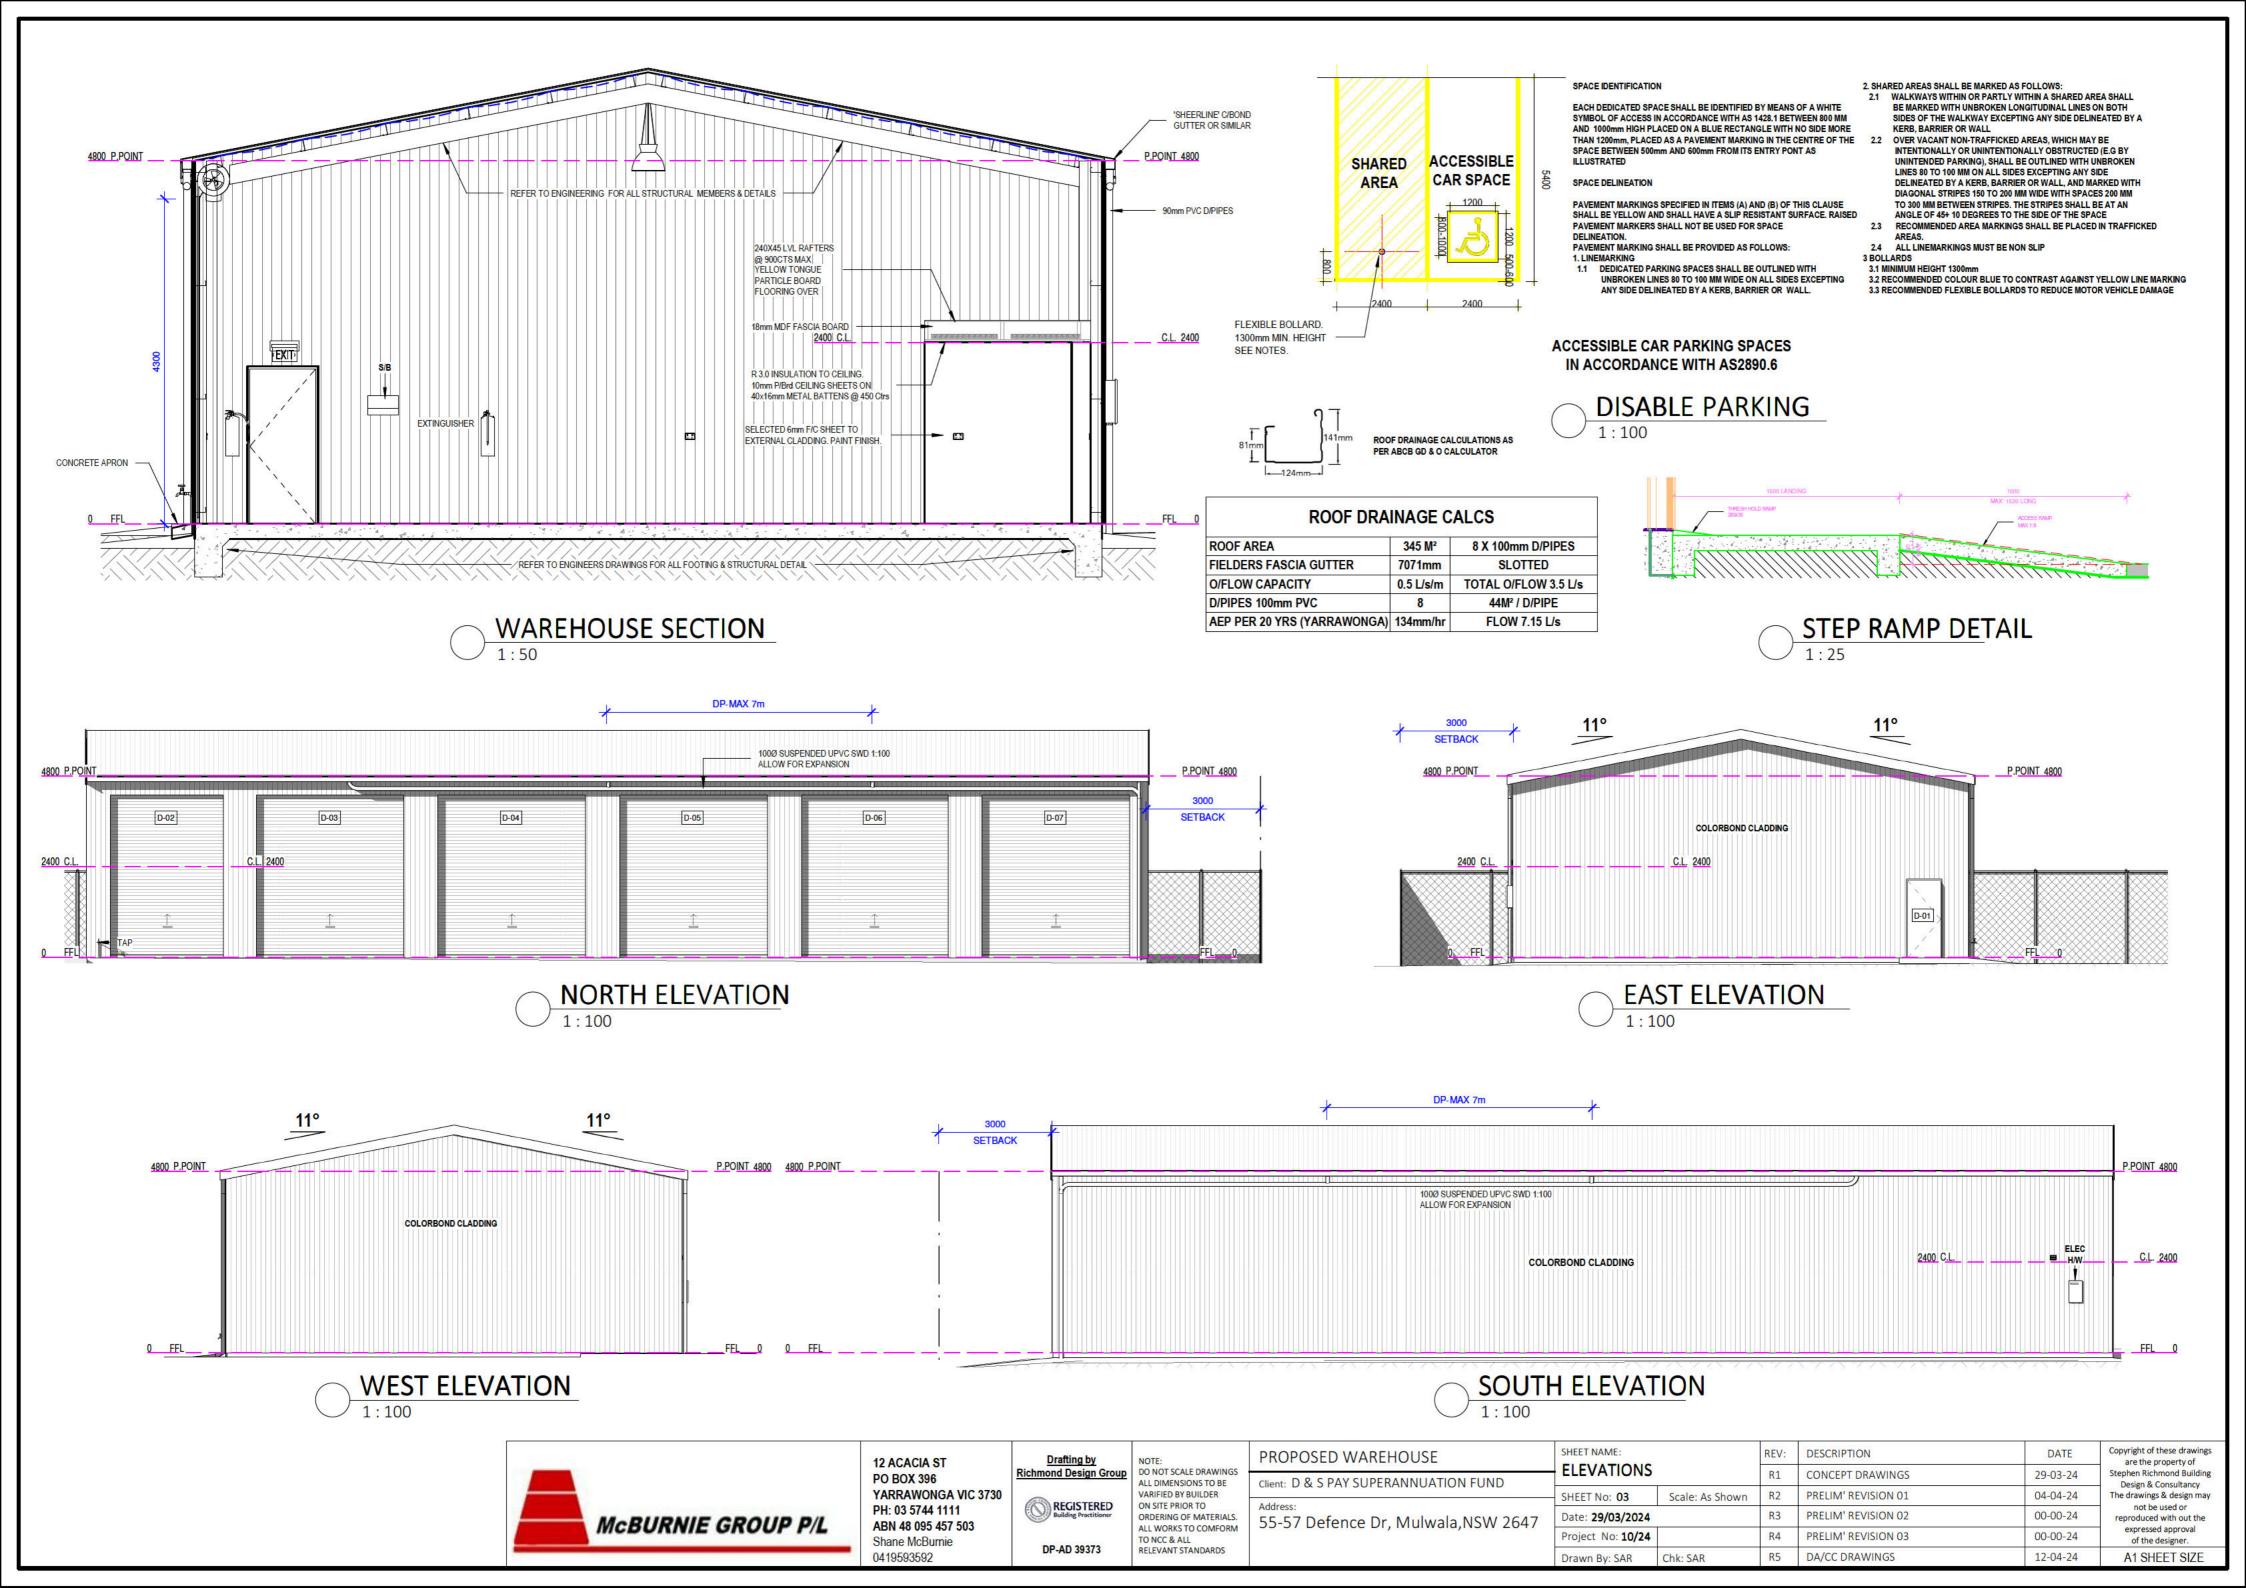

0	COMMERCIAL LED PENDANT LIGHT	Ī	SENSOR FLOOD LIGHT	1	DOUBLE GPO	(P)	TELEPHONE POINT	A	INTERNAL SPLIT SYSTEM UNIT	\longrightarrow	RETURN AIR LOCATION		ELECTRIC HOT WATER SERVICE
0	LED DOWN LIGHT	1	MOTION SENSOR	∇	SINGLE GPO	A	DOUBLE EXTERNAL GPO		CEILING FAN Q	1	THERMOSTAT	\\/	EVAPORATIVE AIR
0	DOUBLE FLUORESCENT GLOBE	•	EXHAUST FAN (DAMPER)	8	ISOLATION SWITCH	∇	SINGLE EXTERNAL GPO		WITH LIGHT CEILING FAN	-D	GAS METER		CONDITIONER
0-	SINGLE FLUORESCENT GLOBE	80	4 GLOBE IXL	(S)	SMOKE DETECTOR	\blacksquare	A/C OUTLET	0	DUCTED HEATING OUTLET	M.BOX	ELECTRICITY METER		RAINWATER TANK PUMP
_	EXTERNAL WALL LIGHT	◆	EMERGENCY EXIT LIGHT	1	TELEVISION POINT	\bowtie	EXTERNAL SPLIT SYSTEM UNIT	RA	RETURN AIR DUCT	HWS	GAS HOT WATER SERVICE	\otimes	DUCTED VACUUM UNIT
		EM-L	EMERGENCY LIGHTING						GAS BOOSTED H/W		SUB BOARD	V	VACUUM OUTLET
N	NOTES: MANHOLE LOCATION IS APPROXIMATE ONLY. EXACT POSITION WILL DEPEND ON TRUSS LAYOUT												

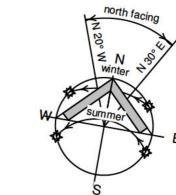

ELECTRICAL LEGEND

GENERAL ELECTRICAL NOTES

ALL LIGHT POINTS WILL BE CENTRALLY LOCATED IN CEILINGS UNLESS SPECIFICALLY REQUESTED BY OTHERS - CONFIRM WITH OWNERS. THE POSITIONS OF DOWNLIGHTS WILL BE AS CLOSE AS POSSIBLE TO THE REQUESTED POSITION, HOWEVER IT IS SUBJECT TO THE POSITION OF ROOF TRUSSES AND OTHER INSTALLATIONS IN THE CEILING POINTS - CONFIRM WITH OWNER. WHERE REQUIRED, PROVIDE POWER FOR RANGEHOOD, HOT PLATES, DISHWASHER, WALL/UNDER BENCH OVEN, MICROWAVE, REFRIGERATOR, EVAPORATIVE COOLING UNIT, HEATING UNIT,

ARTIFICIAL LIGHTING

REFER TO NCC 2022 VOLUME ONE J7D1-J7D6

GARAGE DOOR & HOT WATER SERVICE.

EMERGENCY LIGHTING

REFER TO NCC 2022 VOLUME ONE PART E4 PERFORMANCE REQUIREMENTS E4P1-E4P3 VERIFICATION METHODS E4V1-E4V2 DTS PROVISIONS E4D1-E4D9

EVERY REQUIRED EMERGENCY LIGHTING SYSTEM MUST COMPLY WITH AS/NZS 2293.1. **EXIT SIGNS**

AN EXIT SIGN MUST BE CLEARLY VISIBLE TO PERSONS APPROACHING THE EXIT, AND MUST BE INSTALLED ON, ABOVE OR ADJACENT TO EACH-(A) DOOR PROVIDING DIRECT EGRESS FROM A STOREY TO-

(I) AN ENCLOSED STAIRWAY, PASSAGEWAY OR RAMP SERVING AS A REQUIRED EXIT; AND

(II) AN EXTERNAL STAIRWAY, PASSAGEWAY OR RAMP SERVING AS A REQUIRED EXIT; AND (III) AN EXTERNAL ACCESS BALCONY LEADING TO A REQUIRED EXIT; AND

(B) DOOR FROM AN ENCLOSED STAIRWAY, PASSAGEWAY OR RAMP AT EVERY LEVEL OF DISCHARGE TO A ROAD OR OPEN SPACE; AND

(C) HORIZONTAL EXIT; AND

(D) DOOR SERVING AS, OR FORMING PART OF, A REQUIRED EXIT IN A STOREY REQUIRED TO BE PROVIDED WITH EMERGENCY LIGHTING IN

IF AN EXIT IS NOT READILY APPARENT TO PERSONS OCCUPYING OR VISITING THE BUILDING THEN EXIT SIGNS MUST BE INSTALLED IN APPROPRIATE POSITIONS IN CORRIDORS, HALLWAYS, LOBBIES, AND THE LIKE, INDICATING THE DIRECTION TO A REQUIRED EXIT.

DESIGN AND OPERATION OF EXIT SIGNS

EVERY REQUIRED EXIT SIGN MUST-

(A) COMPLY WITH-(I) AS/NZS 2293.1; OR

DIRECTION SIGNS

(II) FOR A PHOTOLUMINESCENT EXIT SIGN, SPECIFICATION 25; AND

(B) BE CLEARLY VISIBLE AT ALL TIMES WHEN THE BUILDING IS OCCUPIED BY ANY PERSON HAVING THE RIGHT OF LEGAL ENTRY TO THE BUILDING.

EXHAUST SYSTEMS

NCC 2022 VOLUME ONE F8D4

(1) AN EXHAUST SYSTEM INSTALLED IN A KITCHEN, BATHROOM, SANITARY COMPARTMENT OR LAUNDRY MUST HAVE A MINIMUM FLOW RATE OF-

(A) 25 L/S FOR A BATHROOM OR SANITARY COMPARTMENT; AND

(B) 40 L/S FOR A KITCHEN OR LAUNDRY.

(2) EXHAUST FROM A KITCHEN, KITCHEN RANGE HOOD, BATHROOM, SANITARY COMPARTMENT OR LAUNDRY MUST

DISCHARGE DIRECTLY OR VIA A SHAFT OR DUCT TO OUTDOOR AIR.

(3) WHERE SPACE FOR A CLOTHES DRYING APPLIANCE IS PROVIDED IN ACCORDANCE WITH F4D2(1)(B), SPACE MUST

ALSO BE PROVIDED FOR DUCTING FROM THE CLOTHES DRYING APPLIANCE TO OUTDOOR AIR.

(4) (3) DOES NOT APPLY IF A CONDENSING-TYPE CLOTHES DRYING APPLIANCE IS INSTALLED. (5) AN EXHAUST SYSTEM THAT IS NOT RUN CONTINUOUSLY AND IS SERVING A BATHROOM OR SANITARY COMPARTMENT

THAT IS NOT VENTILATED IN ACCORDANCE WITH F6D7 MUST-(A) BE INTERLOCKED WITH THE ROOM'S LIGHT SWITCH; AND

(B) INCLUDE A RUN-ON TIMER SO THAT THE EXHAUST SYSTEM CONTINUES TO OPERATE FOR 10 MINUTES AFTER THE LIGHT SWITCH IS TURNED OFF.

(6) EXCEPT FOR ROOMS THAT ARE VENTILATED IN ACCORDANCE WITH F6D7, A ROOM WITH SPACE FOR DUCTING A CLOTHES DRYING APPLIANCE TO OUTDOOR AIR IN ACCORDANCE WITH (3) MUST BE PROVIDED WITH MAKE-UP AIR IN

ACCORDANCE WITH AS 1668.2-2012

ALL MECHANICAL EXHAUSTS SHALL BE FITTED WITH SELF-CLOSING LOUVRED REGISTER WHERE EXITING THE BUILDING.





FIRE EXTINGUISHER TO BE PLACED NO MORE THAN 20M APART

- CLASS A FIRES - COMBUSTIBLE MATERIALS: CAUSED BY FLAMMABLE SOLIDS SUCH AS WOOD, PAPER AND FABRIC

- CLASS B FIRES - FLAMMABLE LIQUIDS: SUCH AS PETROL, TURPENTINE OR PAINT

NOTE- DRY CHEMICAL POWDER ABE EXTINGUISHER INSTALLED IN ACCORDANCE WITH SECTION 3 OF AS 2444.


FIRE EXTINGUISHERS SHOULD BE MOUNTED NO MORE THAN 1,200 MM. FROM THE FLOOR. LOCATION SIGN INSTALLED ABOVE THE EXTINGUISHER NOT LESS THAN 2 M ABOVE THE FLOOR,

OR AT A HEIGHT THAT ENSURES THE SIGN IS VISIBLE LOCATION AND DISPLAY OF SIGN MIN - 2000MM ABOVE FLOOR LEVEL.


A MINIMUM OF ONE SIGN MUST BE PROVIDED ABOVE OR ADJACENT TO AN EXTINGUISHER

THE EXTINGUISHER AND FIRE POINT LOCATION SIGNS SHALL HAVE A SYMBOL, BORDER AND LETTERS

IN WHITE ON A RED FIELD, COMPLYING WITH AUSTRALIAN STANDARD (AS) 2700-2011.

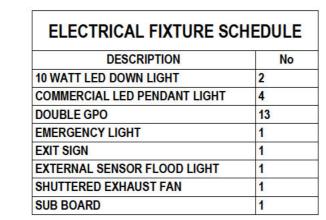

EXACT POSITION WILL DEPEND ON TRUSS LAYOUT

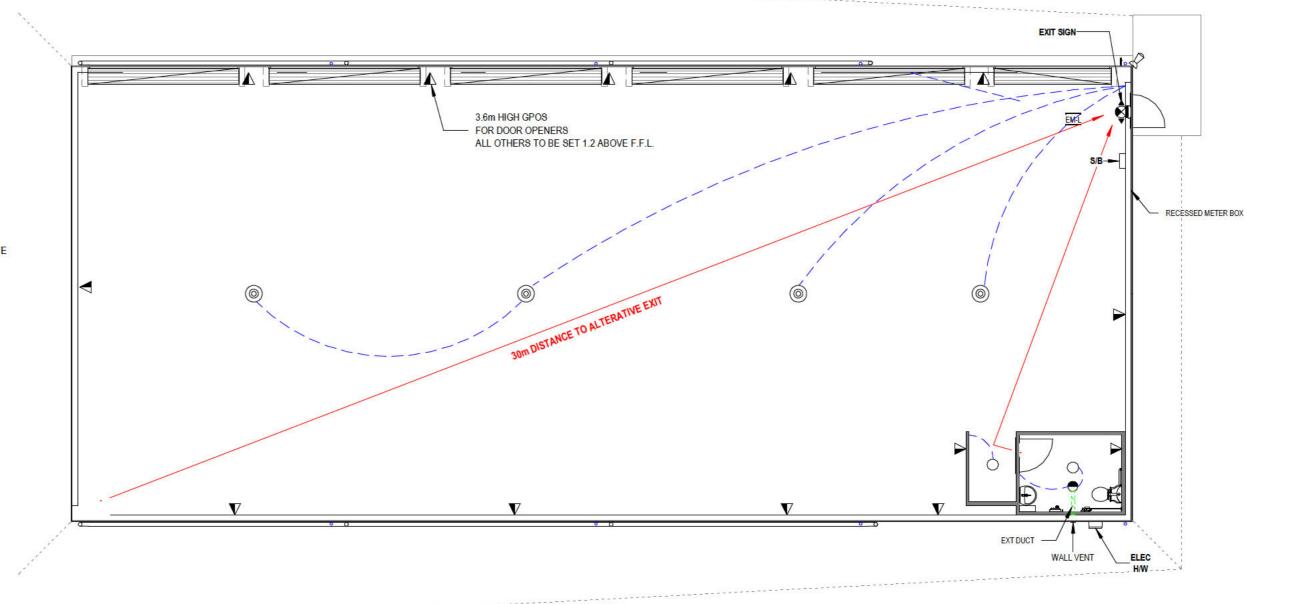

ELEC/LIGHTING PLAN

	McBURNIE GROUP P/L
4	MCDORNIE GROOF FIL

12 ACACIA ST PO BOX 396 YARRAWONGA VIC 3730 PH: 03 5744 1111 ABN 48 095 457 503 Shane McBurnie 0419593592


Drafting by hmond Design Group REGISTERED


DP-AD 39373

VAR ON S RELEVANT STANDARDS

TE: NOT SCALE DRAWINGS	PROPOSED WAREHOUSE
DIMENSIONS TO BE	client: D & S PAY SUPERANNUATION FUND
SITE PRIOR TO DERING OF MATERIALS. WORKS TO COMFORM NCC & ALL	Address: 55-57 Defence Dr, Mulwala,NSW 2647

SHEET NAME:		REV:	DESCRIPTION	DATE	Copyright of these drawi
ELEC/LIGHTII	NG PLAN	R1	CONCEPT DRAWINGS	29-03-24	Stephen Richmond Build
SHEET No: 04	Scale: As Shown	R2	PRELIM' REVISION 01	04-04-24	Design & Consultancy The drawings & design n
Date: 29/03/2024		R3	PRELIM' REVISION 02	00-00-24	not be used or reproduced with out th
Project No: 10/24		R4	PRELIM' REVISION 03	00-00-24	expressed approval of the designer.
Drawn By: SAR	Chk: SAR	R5	DA/CC DRAWINGS	12-04-24	A1 SHEET SIZE

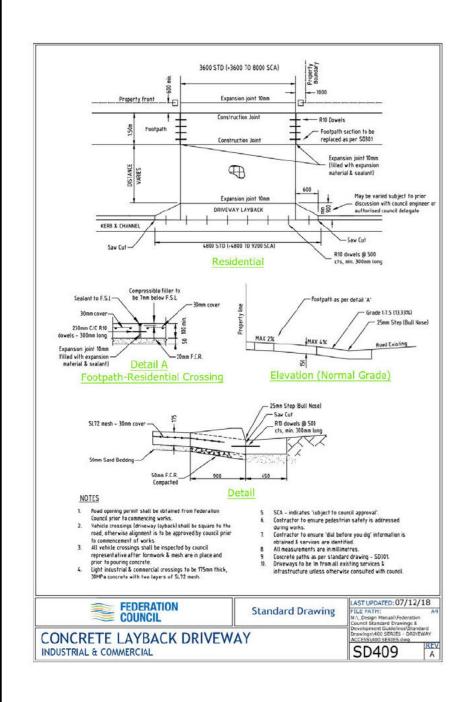

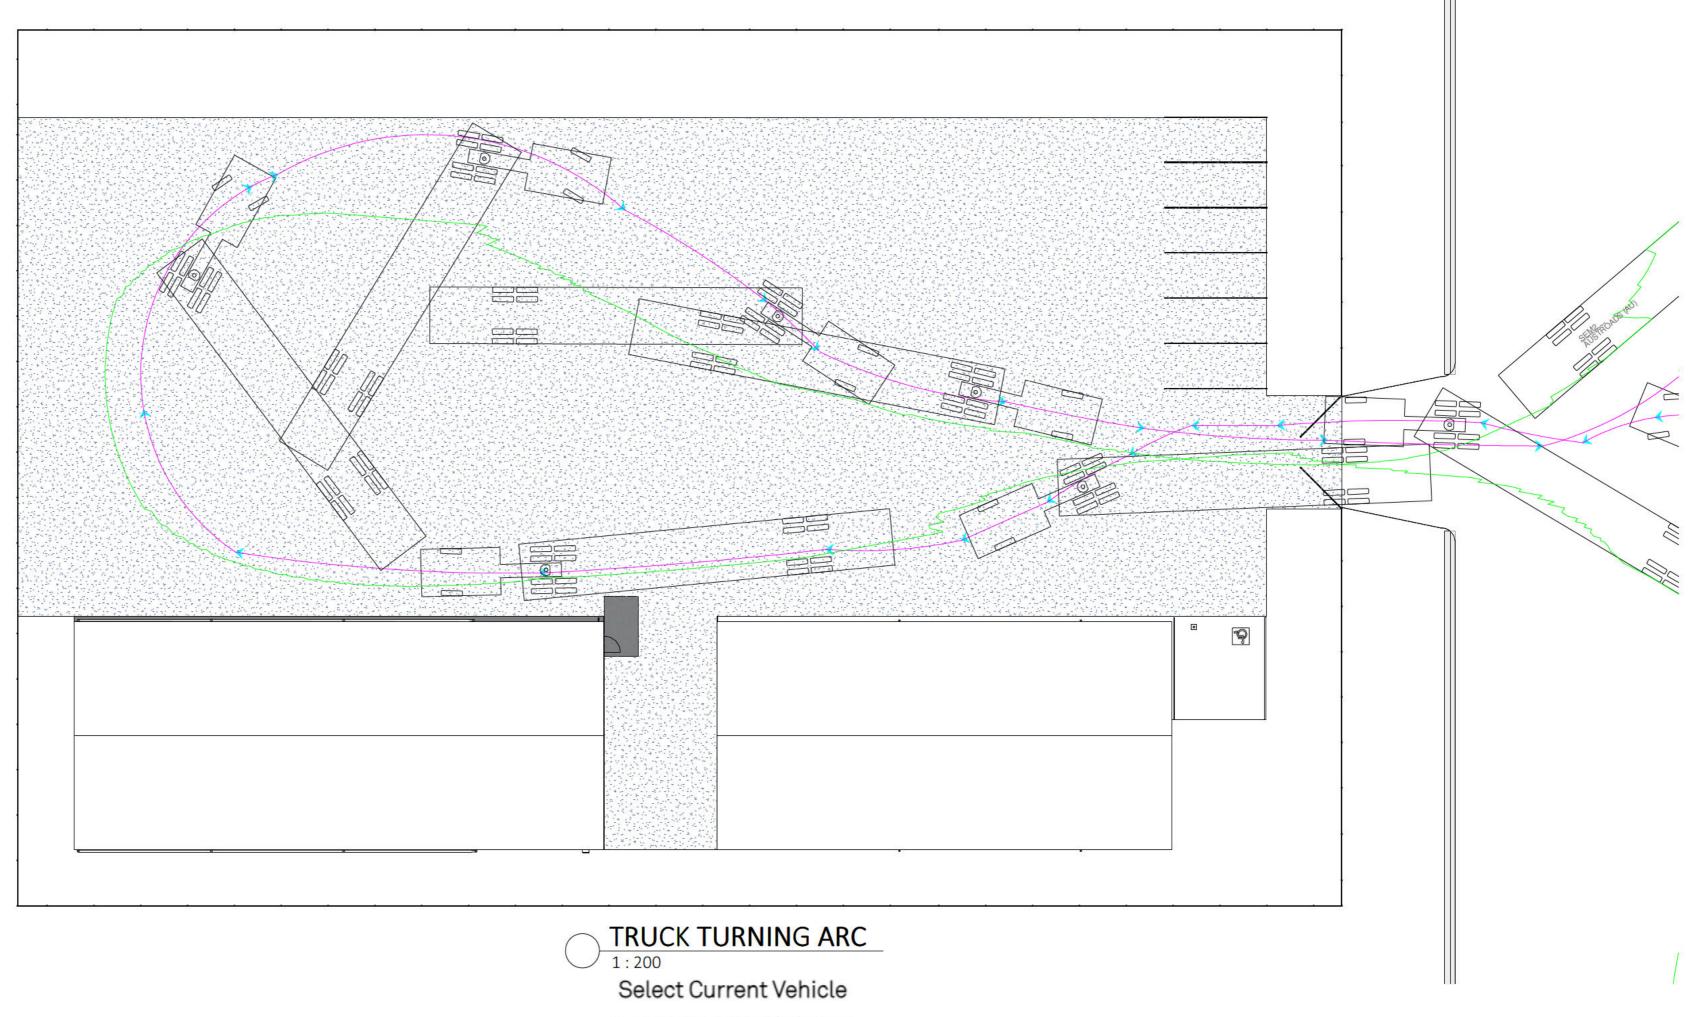

Australia: AUSTROADS (AU): SEM1

Units: Meters

4.20 13.70 9.50 1.30 ₩ 0.40



12 ACACIA ST PO BOX 396 YARRAWONGA VIC 3730 PH: 03 5744 1111 ABN 48 095 457 503 Shane McBurnie 0419593592

5.40

1.60

DP-AD 39373

Prafting by
Richmond Design Group

REGISTERED

NOTE:
DO NOT SCALE DRAWINGS
ALL DIMENSIONS TO BE
VARIFIED BY BUILDER
ON SITE PRIOR TO
OPDERING OF MATERIALS ORDERING OF MATERIALS. ALL WORKS TO COMFORM TO NCC & ALL RELEVANT STANDARDS

PROPOSED WAREHOUSE Client: D & S PAY SUPERANNUATION FUND 55-57 Defence Dr, Mulwala, NSW 2647

Copyright of these drawings SHEET NAME: DESCRIPTION DATE are the property of Stephen Richmond Building **TURNING-DRIVEWAY** R1 CONCEPT DRAWINGS 29-03-24 Design & Consultancy R2 PRELIM' REVISION 01 04-04-24 SHEET No: 05 Scale: As Shown The drawings & design may not be used or reproduced with out the R3 PRELIM' REVISION 02 00-00-24 Date: 29/03/2024 expressed approval Project No: 10/24 R4 PRELIM' REVISION 03 00-00-24 R5 DA/CC DRAWINGS Drawn By: SAR 12-04-24 A1 SHEET SIZE

of the designer.

Statement of Environmental Effects for Minor Impact Developments

1. Applicant Details	
Applicant Name	MCBURNIE GROUP PTY LTD t/a FAIR DINKUM BUILDS YARRAWONGA
Postal Address Your reply will be posted to this address	
Phone	Email

2. Property Details	2. Property Details (of the site to be developed)							
Street Number	55-57	Street	DEFENCE DRIVE					
Town	MULWALA NSW 2647	Site Area m ²	3,247m ²					
Lot/DPs numbers	LOT 41 DP1257361	7.0	5					

3. Proposal details

Describe your proposal in detail, including:

- · the physical description of building and any proposed buildings
- · dimensions of building including height, proposed materials, nominated colour scheme, nature of use
- · signage, disabled access and facilities, driveway access points, parking

The lot currently contains a 24m (L) \times 12m(W) ($288m^2$) shed, constructed by us in 2023. We propose the erection of a $336m^2$, Class 7B engineered shed on the lot. The shed dimensions are: 28m (L), 12m (W), 4.8m (H) with an 11deg Gable Roof to a maximum apex height of 5.97m. The building will be a c-section purlin, Colorbond cladded shed. The color of the shed will be Colorbond® BASALT. The shed will primarily be used as a storage facility for the customer. There is no proposed signage at this point in time. Please refer to the site plans of the development to review the disabled access & facilities, driveway access points & parking.

4. Site details							
What is the area of the site?	2,247m ²						
What is the land zone?	E4						
Describe the site - Provide information on physical features of the site such as shape, slope, vegetation, waterways, access, existing services/infrastructure							
The land currently contains a 288m² shed, constructed by us, in 2023. A perimeter fence encloses the entirety of the land. There is nil viable vegetation on the property at present. The development, per the attached development plans/drafting, include the addition of neat vegetation for the property, for optical streetscape appeal, whilst at the same time, minimising silt and debris that may be currently running into the swale drain at the rear of the property.							
Describe the use of lands adjoining the site. Will the p Consider issues such as noise, privacy, overland flow							
	Due to the land zoning, all adjoining properties are similar in nature. There is nil expected impact on adjoining properties. Due to the slope of the lot, approx. 400mm from front to rear, there should be nil notable impact of overland flows of						
5. Present and Previous Uses							
What is the present use of the site and when did this	use commence? Did this use	receive develop	ment consent?				
The property, since 2023, has contained on it, a 288m Development Consent was acquired for this developm		ness storage pu	irposes.				
List the previous use(s) of the site							
Vacant until 2023. From 2023 until now, since the construction of the exi storing business related, and personal affects.	sting shed, the property has pr	imarily been us	ed as a means of				
Are you relying on existing use rights?		☐Yes	□No				
Have any potentially contaminating activities been unc	dertaken on the property?	☐ Yes	⊠ No				
If yes, please identify:							
6. Existing Structures							
List existing structures on the land There is an existing 288m ² shed located on the prope	rty.						
- 10							
List any structures to be demolished as part of the p	roposal						
The existing shed will remain. The proposed developr	nent will become the second s	tructure located	on the property.				
7. Subdivision							
Do you propose to subdivide?		☐ Yes	⊠ No				
How many existing lots?							
How many proposed lots?							

8. Planning Policies / Controls						
Does the proposal <u>seek a variation</u> to the provisions contained in the following controls?	Yes	No	N/A			
Deniliquin LEP 2013			\boxtimes			
Conargo LEP 2013			\boxtimes			
Deniliquin DCP 2016			\boxtimes			
Corowa LEP 2012	\boxtimes					
Other relevant SEPP / EPI Standards			\boxtimes			
9. Context and Setting						
	Yes	No	N/A			
Will the Development be visually prominent in the surrounding area?	\boxtimes		<u></u> ,			
Will the Development be consistent with the existing streetscape or Council Policy?	\boxtimes					
Will the development be out of character with the surrounding area?		\boxtimes				
The development will not appear out of character to the area, visually. The development is identical to the building located at 55-57 Defence Drive Mulwala, albeit in a different location on the property. This development, due to the proposed use of land in terms of additional vegetation, will be an improvement on the area's existing developments.						
10. Access and Traffic	Yes	No	N/A			
Is legal and practical access available to the site?	\boxtimes					
Are additional access points to road network required?		\boxtimes				
Has vehicle manoeuvring and onsite parking been addressed in the design?	\boxtimes					
Will the development increase local traffic movements/volumes? □ □ □						
If yes, please specify how much:						
11. Utilities and Services						
Water supply - Please provide details of existing and any proposed arrangements						
To be connected in unison with existing shed.						
Sewer - Please provide details of existing and any proposed arrangements						
To be connected to existing services.						
Storm Water connection / disposal - Please provide details of existing and any pro-	oposed arran	gements				
The storm water point has been identified in the site plan and development map, inc	luded in the a	application.				
Septic Tank / Effluent disposal - Please provide details of existing and any propos	ed arrangem	ents				
Topilo Talin Talindon diopodal - Floudo provide details of existing and any proposed analigements						

Other						
40.7						
	and Biodiversity Considerations	□Vee	⊠ Na			
is the land identified as a	critical habitat or as part of a critical habitat?	Yes	⊠ No			
1-11-1-1-1-1-1-1-1-1-1-1-1-1-1-1-1-1-1-1	If yes, you need to submit a Species Impact Sta	tement to acc	ompany your application			
	Is the development likely to significantly affect threatened species populations or ecological communities or their habitat?					
	If yes, you need to submit a Species Impact Sta	tement to acc	ompany your application			
Does the proposal include	e land clearing of native vegetation?	☐ Yes	⊠ No			
		lf n	o, proceed to Section 13			
	re land clearing of vegetation within an area identified on ap as defined under the Biodiversity Conservation	☐ Yes	□ No			
	ed the Biodiversity Offset Scheme Thresholds in of the Biodiversity Conservation Act 2016?	☐ Yes	□No			
1000 V 1000 1000 1000 1000 1000 1000 10	the above 2 questions, please attach a Biodiversity Dev in accordance with part 6.12 of t H of the above 2 questions, please attach a "test of signi in accordance with section 7.3 of t	he Biodiversit ficance" also	y Conservation Act 2016 known as the 5 part test,			
	result in air, noise or water pollution? (Including during	⊠ Yes	□No			
construction works)		△ res	NO			
If yes, please describe the	e source of pollution and what measures will be implement	ed to control p	pollution			
Air (Dust, Odour)	There should be limited/nil air/dust pollution as a result o will consist of grass coverage for non-vehicle access are internal hard surface driveway.					
Noise	Due to the nature of use of the development, minimal/nil	additional noi	se pollution is expected.			
Water	There is a chance of minimal contamination to the swale drain potentially caused by rain, which, taking into account the slope of the block, may result in the carrying of dirt/dust/silt into the drain. It is a consideration, as part of the development, to add a grass apron to the rear of the property, at the adjoining driveway, as a buffer point between the driveway and the drain, as an additional preventative measure.					
Is the development likely	y to result in any form of sediment run- off?	⊠ Yes	□ No			
Please refer to above co	mments.					
Is the land flood prone?		☐ Yes	⊠ No			
If yes, describe the prop	osed finished floor levels of habitable rooms					
Is the land classed as b	ushfire prone?	☐ Yes	⊠ No			

If yes, and if your proposal is for the construction of a dwelling or dwelling additions/alteration, you will need to undertake BAL Risk Assessment in accordance with NSW RFS Planning requirements and provide to Council. If you determine your development is a higher risk BAL 40 or BAL FZ, you will need to consult with a Bushfire consultant to assist further.

Do you propose to clear any vegetation and/or trees (Non-Native) as part of your proposal?	☐ Yes	⊠ No			
If yes, please provide details					
14. Aboriginal Cultural Heritage					
Is the proposed site of the development in close proximity to Aboriginal cultural heritage (ACH) indicators (such as the Edward River or sites that are registered within the Aboriginal Heritage Information Management System (AHIMS) which may include culturally modified trees and known burial)?	☐ Yes	⊠ No			
If yes, you must submit evidence that they have carried out due diligence in determine Aboriginal objects.	ning that the acti	ons will not harm			
Attention is drawn to the <i>Due Diligence Code of Practice for the Protection of Aboriginal Objects in NSW</i> (the Code) and in particular the generic Due Diligence process on pages 10 – 14 of the Code. Anyone who exercises due diligence in determining that their actions will not harm Aboriginal objects has a defence against prosecution for the strict liability offence if they later harm an object. Further information on the code is available at the OEH website: www.environment.nsw.gov.au/resources/cultureheritage/ddcop/10798ddcop.pdf					
As a minimum the applicant is required to undertake a Due Diligence assessment identify:	n accordance wi	th the Code to			
 Whether or not Aboriginal objects are, or are likely to be, present in the propose To determine whether or not the proposed activities are likely to harm Aborigin 	88 000 St 1805				
To determine whether further assessment in the form of an Aboriginal Cultural Heri Aboriginal Heritage Impact Permit (AHIP) application is required.	itage Assessmer	nt (ACHA) and/or an			
Briefly summarise below the findings of your Due Diligence assessment – detail you AHIMS basic search and any other relevant information sourced	ur site inspection	, results from your			
15. Presumptive Title					
Is your development proposal located on the riverbank?	☐ Yes	⊠ No			

If yes, please advise / provide evidence if you have presumptive title (own to the middle thread of the river).

This information can be obtained from Crown Lands – Phone 1300 886 235.

16. Operational and Management Details

NOTE

This section does not relate to residential development and is generally only applicable to commercial, industrial, rural industrial or tourism developments

Describe in detail the proposed busine	ss/activity			
The shed will be used as a storage fac affects of A1 Windscreens.	ility of the joint tenants per tl	ne property	title, a	as well as the storage of business
Hours of operation				
Monday to Friday		AM	to	PM
Saturday		AM	to	PM
Sunday		AM	to	PM
Extended hours		AM	to	PM
Total number of staff members		0-5		
Maximum number of staff members on	duty at any one time	0-2		
Maximum number of clients/customers	expected in a day	N/A – Due to intended use as storage facility		
Maximum number of clients/customers	expected at any one time	N/A – Due to intended use as storage facility		
Expected vehicle types associated with	n the proposal	truck has	been	plan, the attendance of a b-double considered, however primarily, les will be accessing the lot
Number of car parking spaces provid	ed	Refer to	olans	
Location of car parking spaces provide	d	Refer to p	olans	
Describe arrangements transport, load vehicles and frequency of truck moven		(including	expec	ted frequency of deliveries, size of
There will be limited access of larger von minimal traffic access. Albeit however truck, weekly, at most				
List machinery associated with the pro	posed business / activity			
List the type and quantity of raw mater	ials, finished products and w	aste materi	als	

Waste of the development will be removed from the property and disposed of based on the disposal requirements of the materials. E.g. steel, will be transported back to McBurnie Group for proper disposal and recycling.

Identify any processes or materials that may be potentially hazardous and identify management